STAGE 03 - BUILDING C M-PARK - DEVELOPMENT APPLICATION 11-17 KHARTOUM ROAD & 33-39 TALAVERA ROAD, MACQUARIE PARK

DATE 01/10/2021



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PROJECT NAME M-PARK STAGE 03 -17 KHARTOUM ROAD & 33-39 TALAVERA ROAD, MACQUAI PROJECT NUMBER 550008



SCALE @A3

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STAGE 03 - BUILDING C

	DA-001	Cover Sheet
	DA-002	Drawing List
	DA-003	Existing Site Plan
	DA-004	Demolition Site Plan
DRAWINGS AMENDED \longrightarrow	DA-005	Proposed Site Plan
	DA-007	Staging Site Plan
	DA-010	Basement 3 Plan
	DA-011	Basement 2 Plan
	DA-012	Basement 1 Plan 🗧
	DA-013	Ground Plan
	DA-014	Level 1 Plan
	DA-015	Level 2 Plan
	DA-016	Level 3 Plan
	DA-017	Level 4-5 Plan
	DA-018	Level 6 Plan
	DA-019	Roof Plan
	DA-021	North Elevation
	DA-022	East Elevation }

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DA-023	South Elevation
DA-024	West Elevation
DA-026	Section North-South
DA-027	Section East-West
DA-028	Facade Intent Details
DA-030	Shadow Diagrams
DA-040	GFA Area Plans
DA-050	Materials and Finishes

DRAWING AUTHOR Stockland

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PROJECT NAME **M-PARK STAGE 03** 11-17 KHARTOUM ROAD & 33-39 TALAVERA ROAD, MACQUARIE PARK NS PROJECT NUMBER 550008

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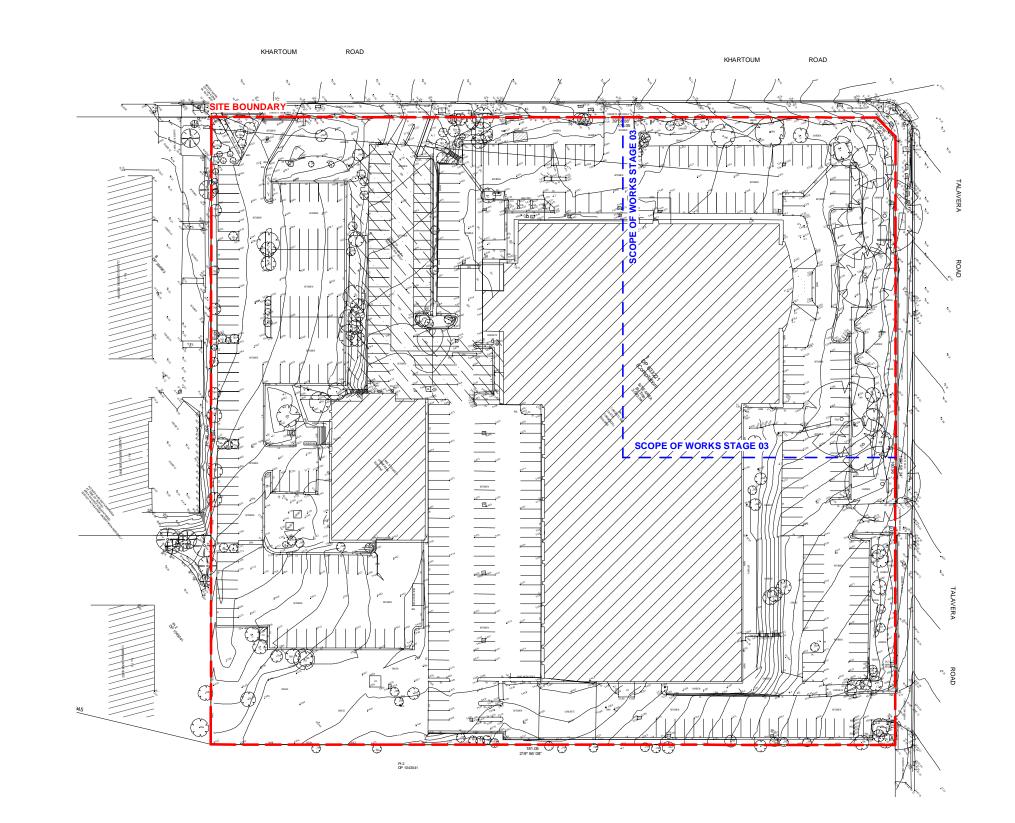
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DRAWINGS AMENDED

DRAWING	REVISION
Drawing List	11
DRAWING NUMBER	DATE
DA-002	01/10/21





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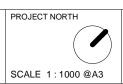
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PROJECT NAME M-PARK STAGE 03 11-17 KHARTOLM ROAD & 33-39 TALAVERA ROAD, MACQUARIE PARK NSW PROJECT NUMBER 550008

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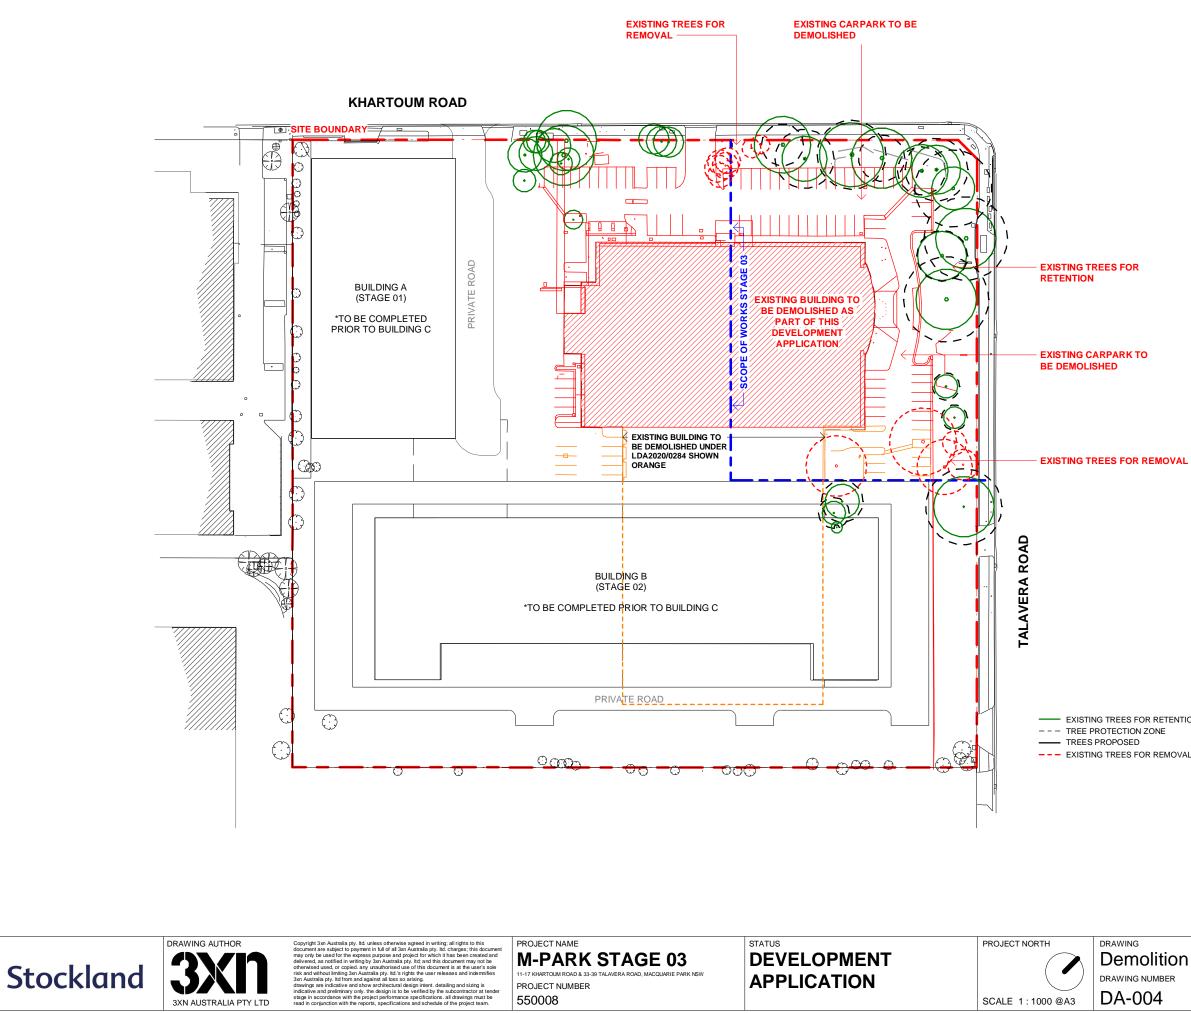
DEVELOPMENT APPLICATION



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Existing Site Plan	10
DRAWING NUMBER	DATE
DA-003	01/10/21




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----- EXISTING TREES FOR RETENTION --- TREE PROTECTION ZONE --- EXISTING TREES FOR REMOVAL

	REVISION
Demolition Site Plan	10
DRAWING NUMBER	DATE
DA-004	01/10/21



NOTE:

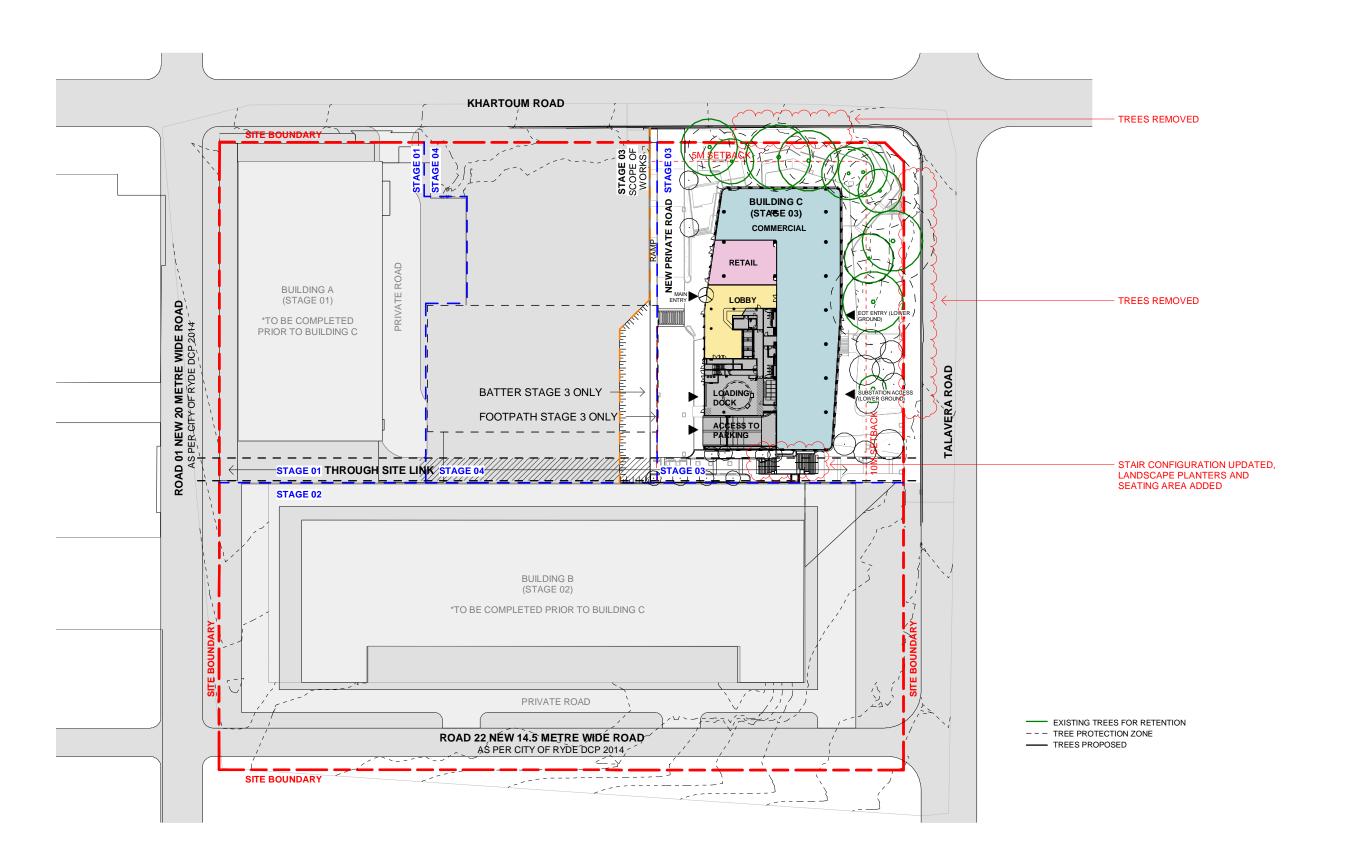PROJECT NORTH

SCALE 1:1000 @A3



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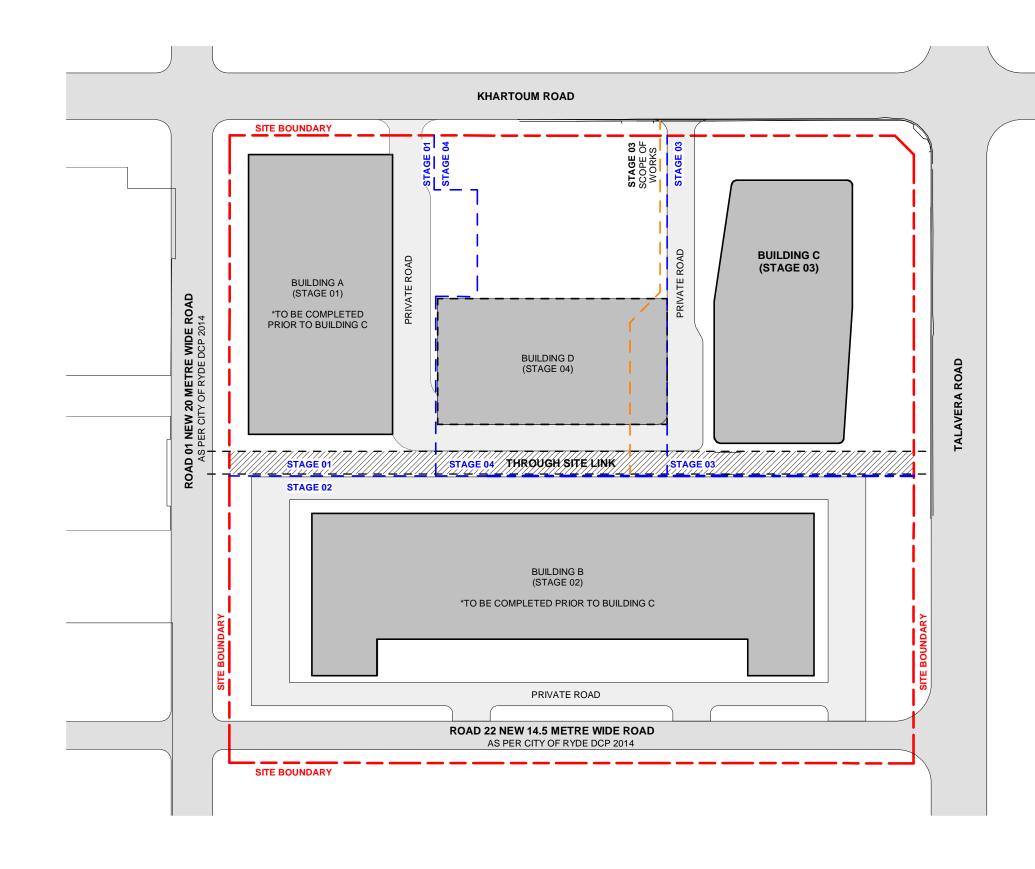
A3

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DRAWING REVISION Proposed Site Plan 11 DRAWING NUMBER DATE DA-005 01/10/21

FOOTPRINT AND POSITION OF BUILDING A & B IS INDICATIVE ONLY





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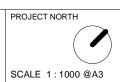
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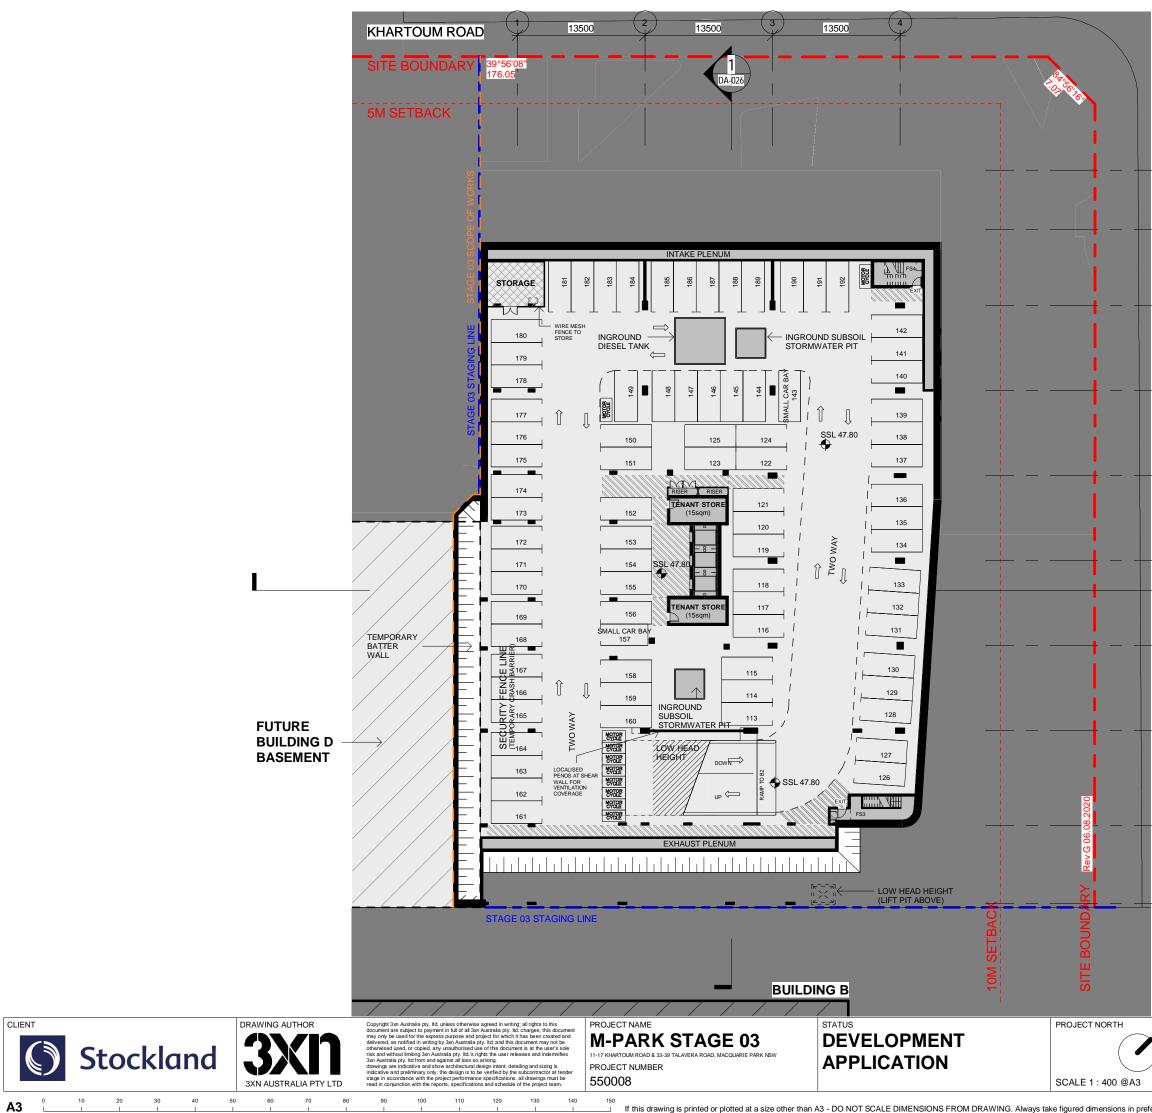
PROJECT NAME **M-PARK STAGE 03** 11-17 KHARTOUM ROAD & 33-39 TALAVERA ROAD, MACQUARIE PARK NSW PROJECT NUMBER 550008


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DRAWING Staging Site Plan	REVISION 11
DRAWING NUMBER	DATE
DA-007	01/10/21





Parking Total (Car Spaces)		
Туре	Total	

BASEMENT 1

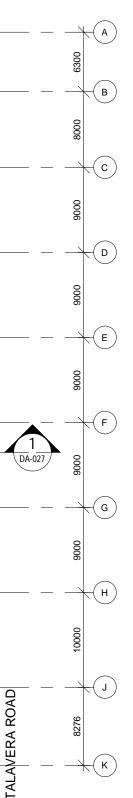5000 x 2300 SMALL CAR BAY	1
5400 x 2300 SMALL CAR BAY	1
5400 x 2400 ACCESSIBLE	6
5400 x 2400 CAR SHARE	2
5400 x 2400 CHARGE BAY	1
5400 x 2400 MAINTENANCE	1
5400 x 2400 STANDARD BAY	26
5400 x 3200 CAR SHARE	1
(DDA)	

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BASEMENT 2

5000 x 2300 SMALL CAR BAY	
5400 x 2300 SMALL CAR BAY	5
5400 x 2400 CHARGE BAY	3
5400 x 2400 STANDARD BAY	64
73	

BASEMENT 3

5000 x 2300 SMALL CAR BAY	1
5400 x 2300 SMALL CAR BAY	1
5400 x 2400 STANDARD BAY	78
80	

Grand total: 192

Parking Total (Motorcycle Spaces)	
Туре	Total

BASEMENT 2 2500x1200 MOTORCYCLE 2


BASEMENT 3

2500x1200 MOTORCYCLE	10	
10		

Grand total: 12




REVISION	
10	
DATE	
01/10/21	

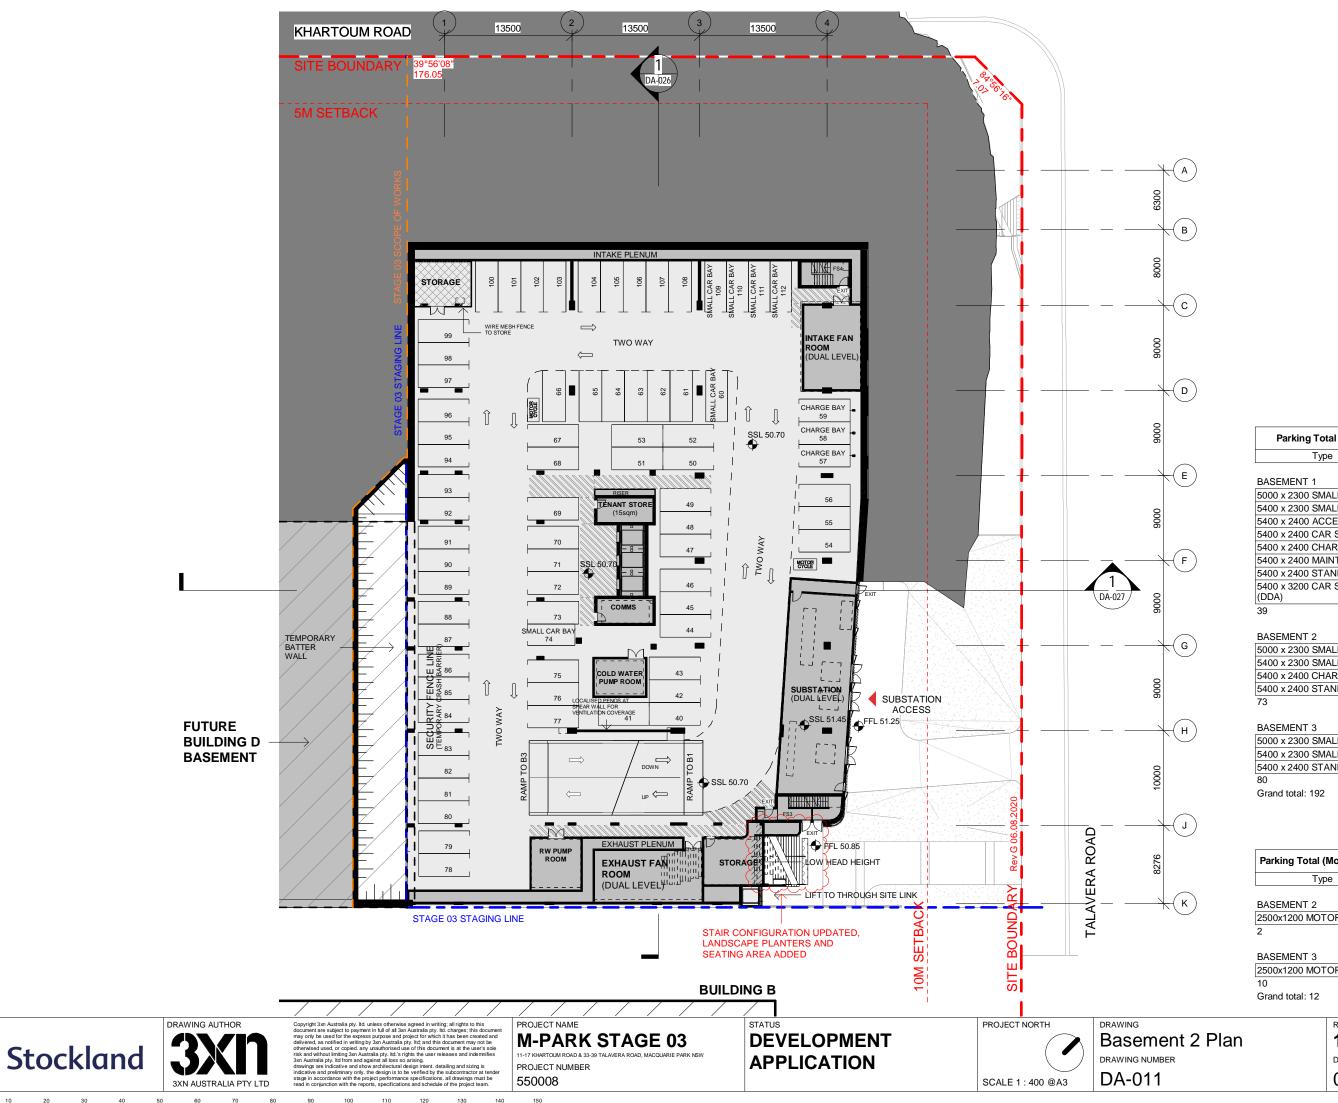

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Parking Total (Car Spaces)	
Type Tot	al

5400 × 2400 ACCESSIBLE 6 5400 × 2400 CAR SHARE 2 5400 × 2400 CHARGE BAY 1 5400 × 2400 CHARGE BAY 1 5400 × 2400 MAINTENANCE 1 5400 × 2400 STANDARD BAY 26 5400 × 3200 CAR SHARE 1		
5400 × 2400 ACCESSIBLE 6 5400 × 2400 CAR SHARE 2 5400 × 2400 CHARGE BAY 1 5400 × 2400 CHARGE BAY 1 5400 × 2400 MAINTENANCE 1 5400 × 2400 STANDARD BAY 26 5400 × 3200 CAR SHARE 1	5000 x 2300 SMALL CAR BAY	1
5400 × 2400 CAR SHARE 2 5400 × 2400 CHARGE BAY 1 5400 × 2400 CHARGE BAY 1 5400 × 2400 MAINTENANCE 1 5400 × 2400 STANDARD BAY 26 5400 × 3200 CAR SHARE 1	5400 x 2300 SMALL CAR BAY	1
5400 x 2400 CHARGE BAY 1 5400 x 2400 MAINTENANCE 1 5400 x 2400 STANDARD BAY 26 5400 x 3200 CAR SHARE 1	5400 x 2400 ACCESSIBLE	6
5400 x 2400 MAINTENANCE 1 5400 x 2400 STANDARD BAY 26 5400 x 3200 CAR SHARE 1	5400 x 2400 CAR SHARE	2
5400 x 2400 STANDARD BAY 26 5400 x 3200 CAR SHARE 1	5400 x 2400 CHARGE BAY	1
5400 x 3200 CAR SHARE 1	5400 x 2400 MAINTENANCE	1
	5400 x 2400 STANDARD BAY	26
(DDA)	5400 x 3200 CAR SHARE	1
	(DDA)	

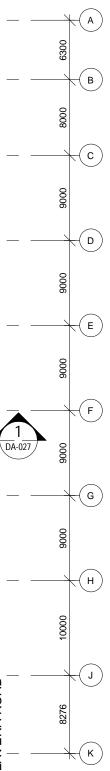5000 x 2300 SMALL CAR BAY	
5400 x 2300 SMALL CAR BAY	5
5400 x 2400 CHARGE BAY	3
5400 x 2400 STANDARD BAY	64
73	


5000 x 2300 SMALL CAR BAY	1
5400 x 2300 SMALL CAR BAY	1
5400 x 2400 STANDARD BAY	78
80	

Parking Total (Motorcycle Spaces)	
Туре	Total

2500x1200 MOTORCYCLE 2


2500x1200 MOTORCYCLE	10
10	

REVISION	
10	
DATE	
01/10/21	

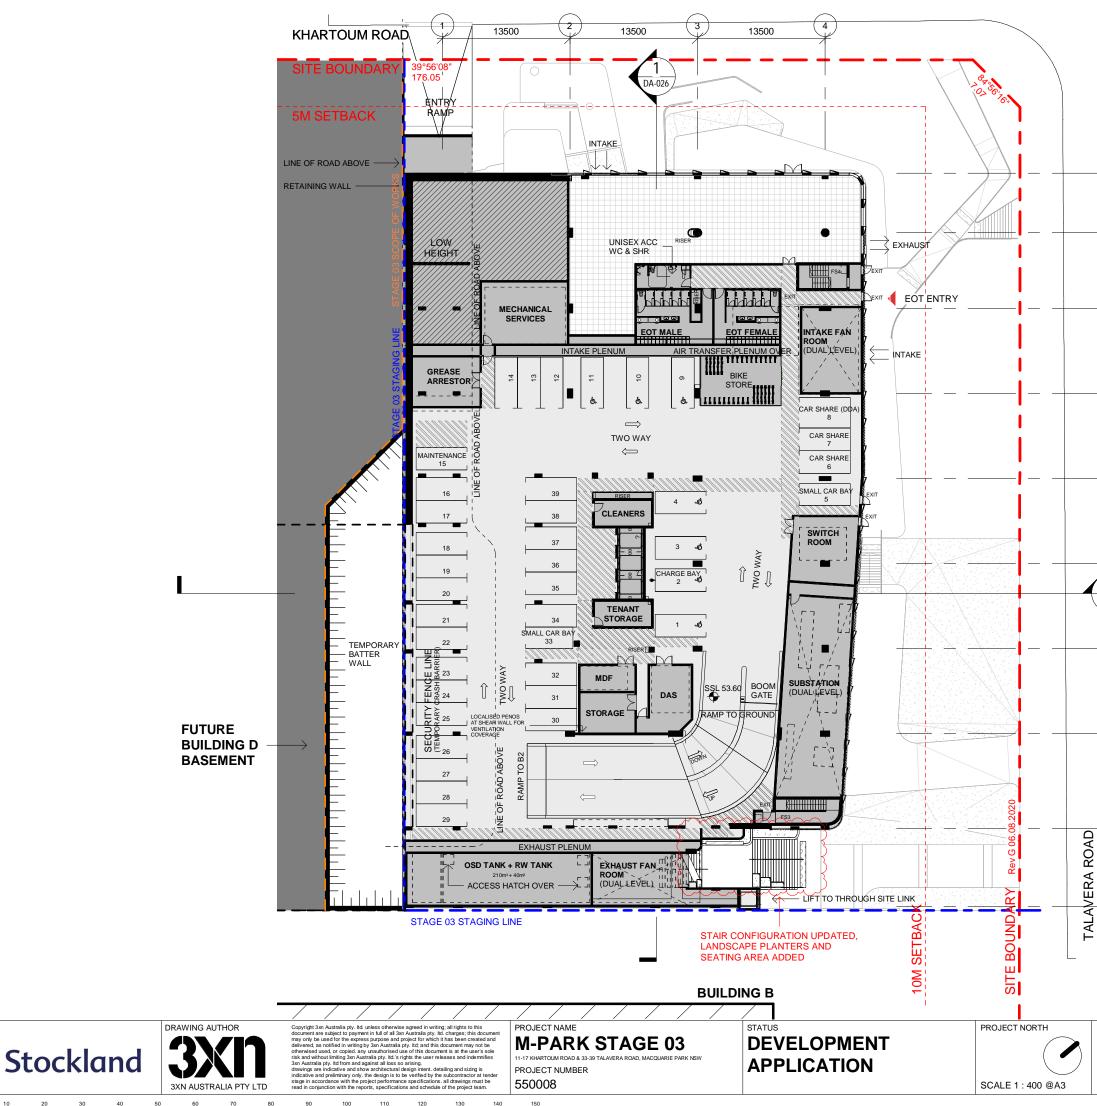

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10 DATE

Basement 1 Plan DRAWING NUMBER DA-012

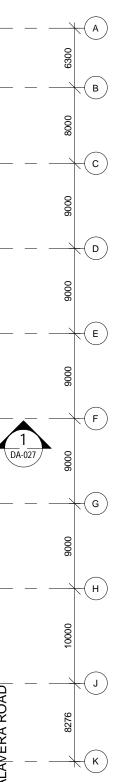REVISION 01/10/21

Parking Total (Motorcycle Spaces) Type

Total

BASEMENT 2

2500x1200 MOTORCYCLE 2

Grand total: 12

10

BASEMENT 3 2500x1200 MOTORCYCLE 10

80 Grand total: 192

BASEMENT 3	
5000 x 2300 SMALL CAR BAY	1
5400 x 2300 SMALL CAR BAY	1

13	
BASEMENT 3	
5000 x 2300 SMALL CAR BAY	1
5400 x 2300 SMALL CAR BAY	1

BASEMENT 3	
5000 x 2300 SMALL CAR BAY	1
5400 x 2300 SMALL CAR BAY	1
	78

39

BASEMENT 2 5000 x 2300 SMALL CAR BAY 1 5400 x 2300 SMALL CAR BAY 5 5400 x 2400 CHARGE BAY 3 5400 x 2400 STANDARD BAY 64

BASEMENT 1	
5000 x 2300 SMALL CAR BAY	1
5400 x 2300 SMALL CAR BAY	1
5400 x 2400 ACCESSIBLE	6
5400 x 2400 CAR SHARE	2
5400 x 2400 CHARGE BAY	1
5400 x 2400 MAINTENANCE	1
5400 x 2400 STANDARD BAY	26
5400 x 3200 CAR SHARE	1
(DDA)	

Parking Total (Car Spaces)

Total

Туре

Ryde DCP: Up to 10% of the required car spaces may be nominated as "small"

COURIER N/A ACCESSIBLE

1-50=2 spaces + 1 per 50 thereafter 5 spaces

CHARGE BAY

Aust Standards:

MOTORCYCLE


N/A

CAR SHARE

BICYCLE 43 secure spaces

CARPARKING TARGETS STANDARD A maximum of 1 space / 60 m2 Maximum: 188 cars


DRAWING

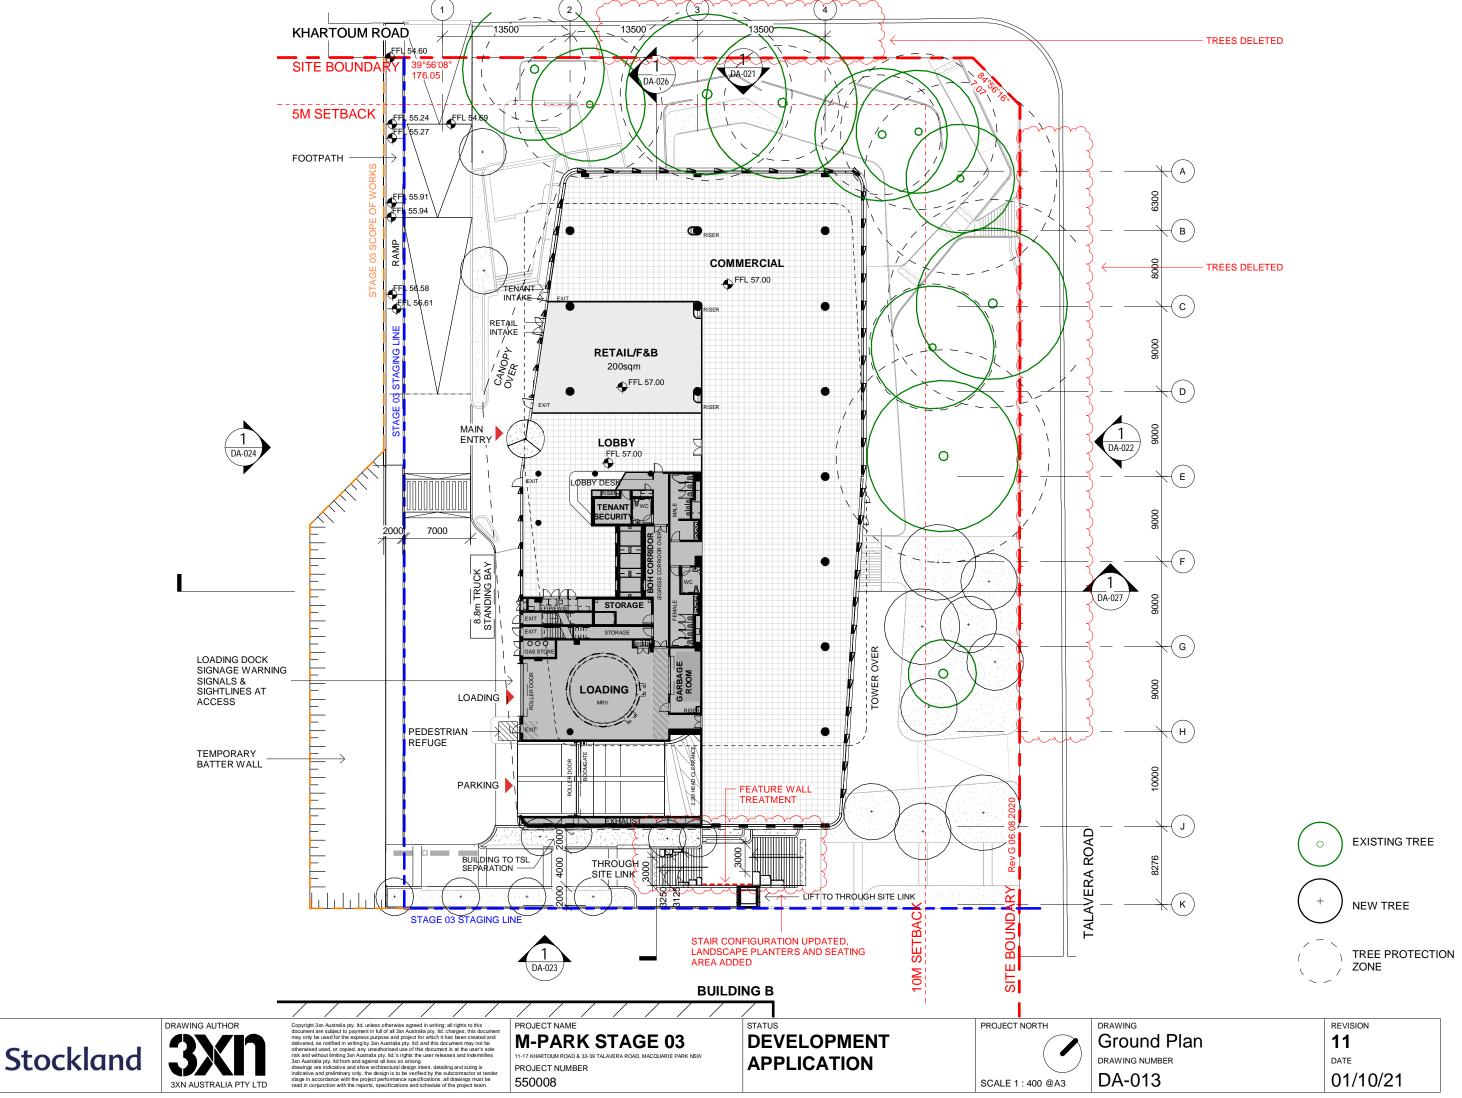

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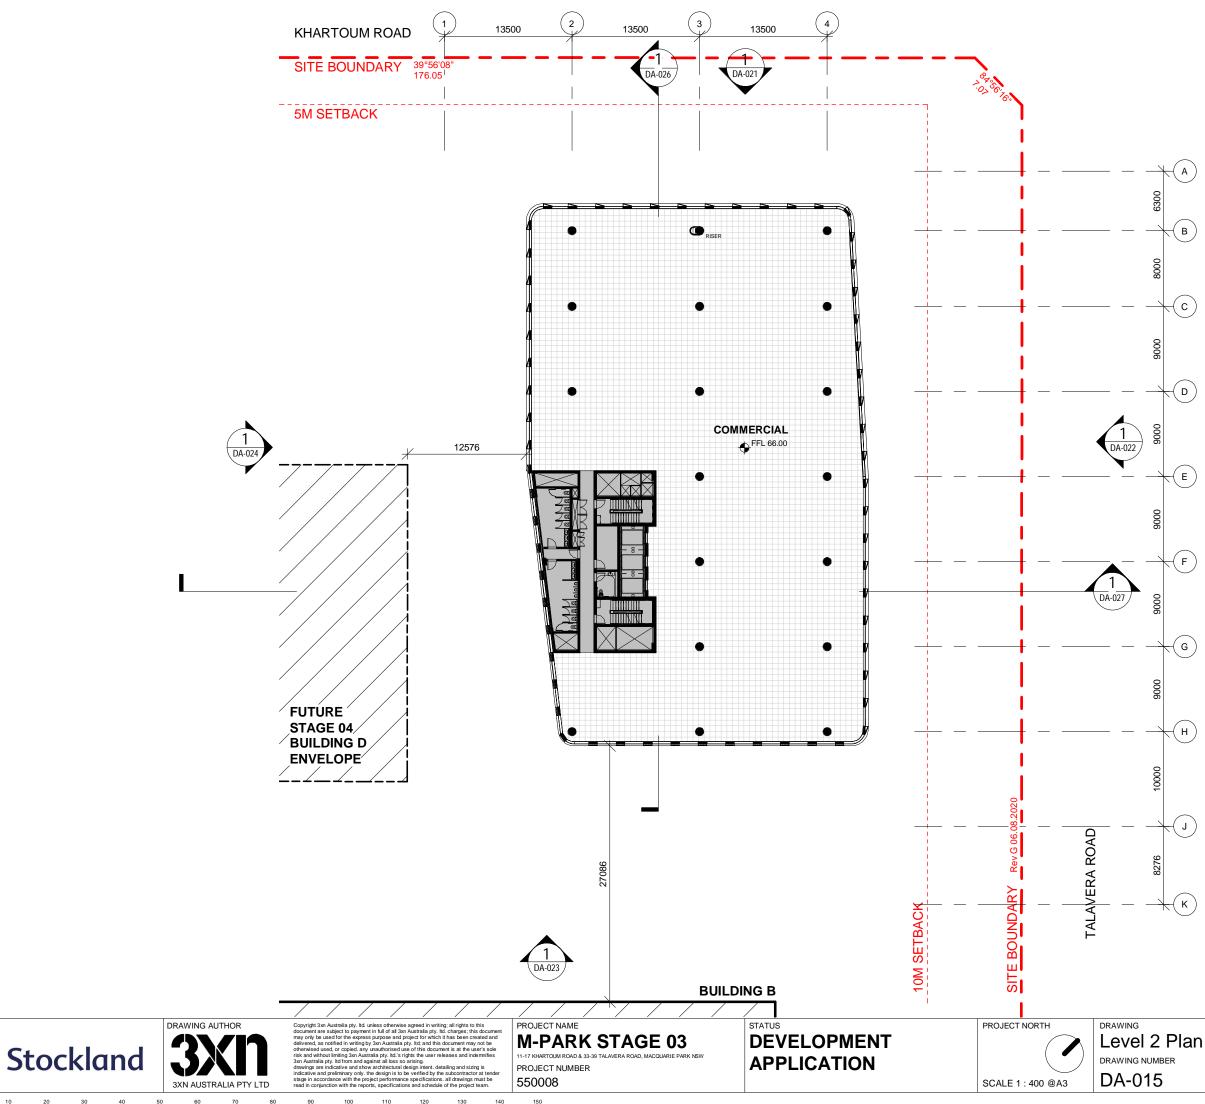


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DRAWING	REVISION
Level 1 Plan	11
DRAWING NUMBER	DATE
DA-014	01/10/21

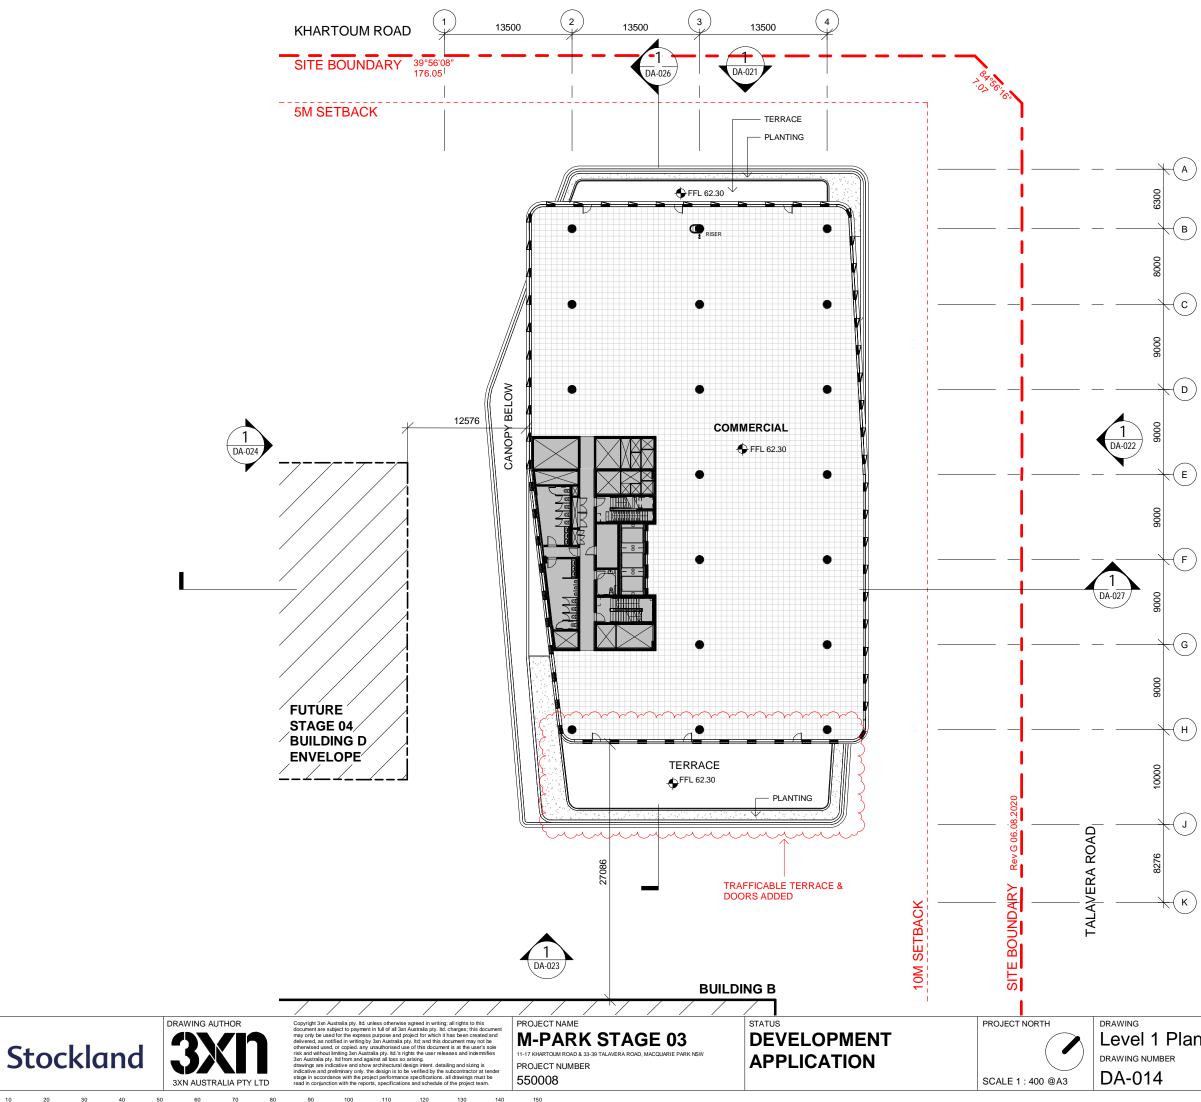


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DRAWING Level 2 Plan	REVISION 11
DRAWING NUMBER	DATE
DA-015	01/10/21




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	REVISION
Level 3 Plan	11
DRAWING NUMBER	DATE
DA-016	01/10/21

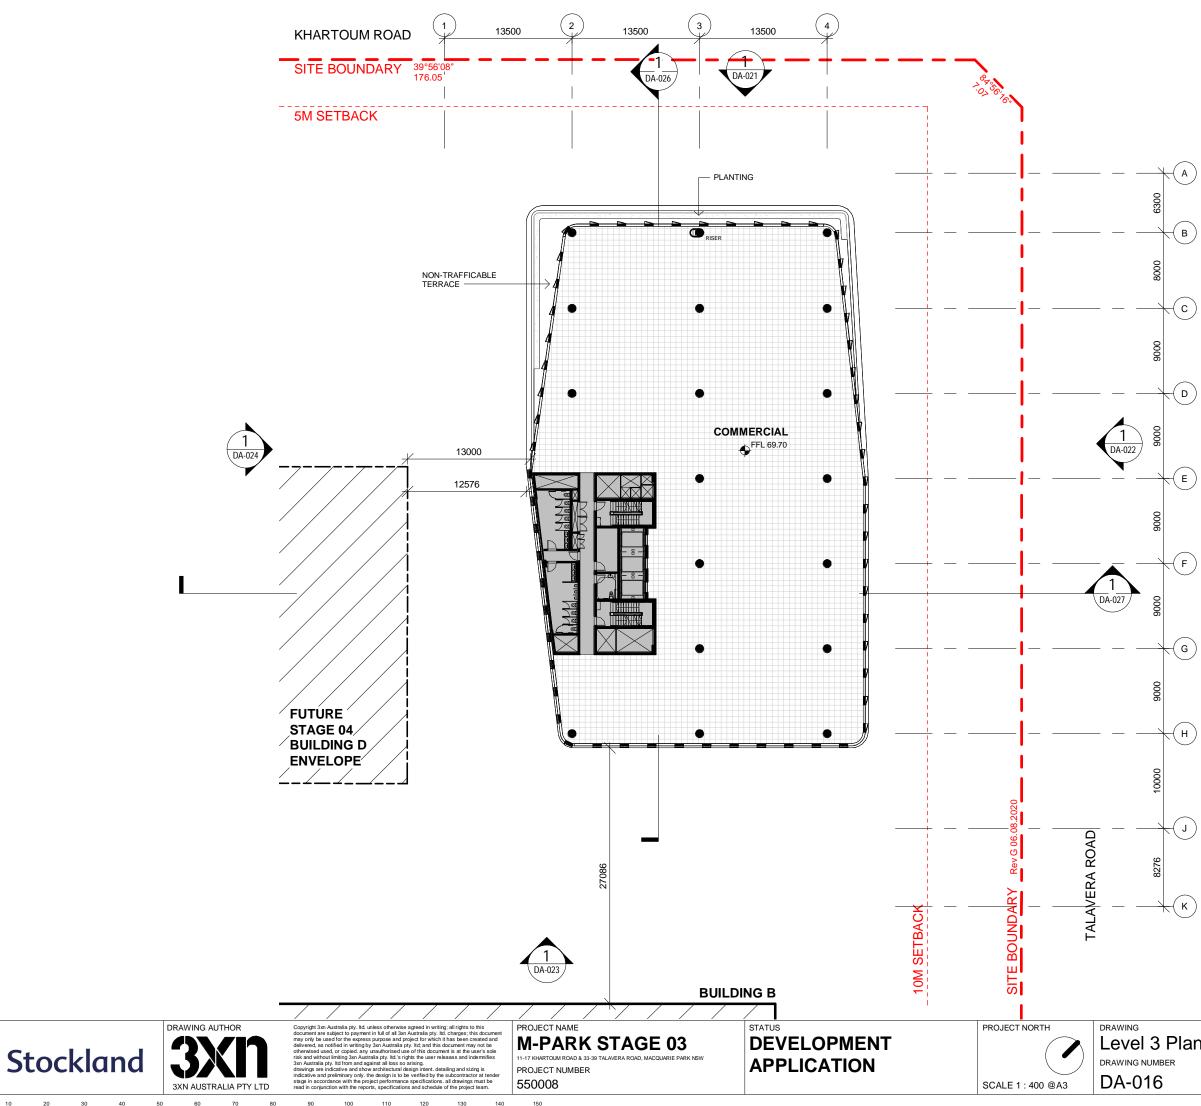


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DRAWING Level 4-5 Plan	REVISION 11
DRAWING NUMBER	DATE
DA-017	01/10/21

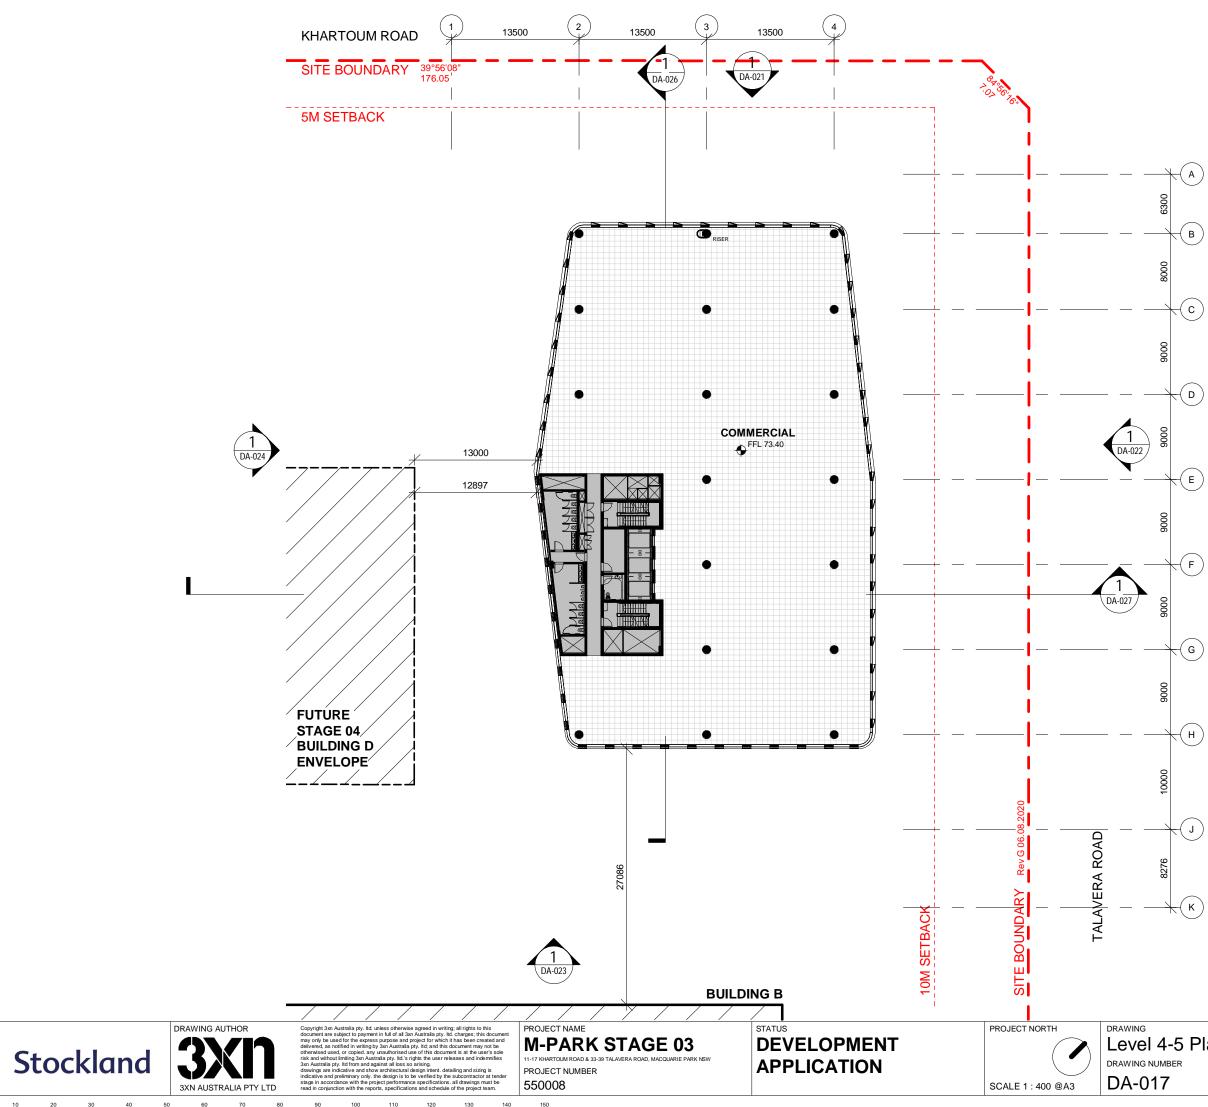


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	REVISION
Level 6 Plan	11
DRAWING NUMBER	DATE
DA-018	01/10/21

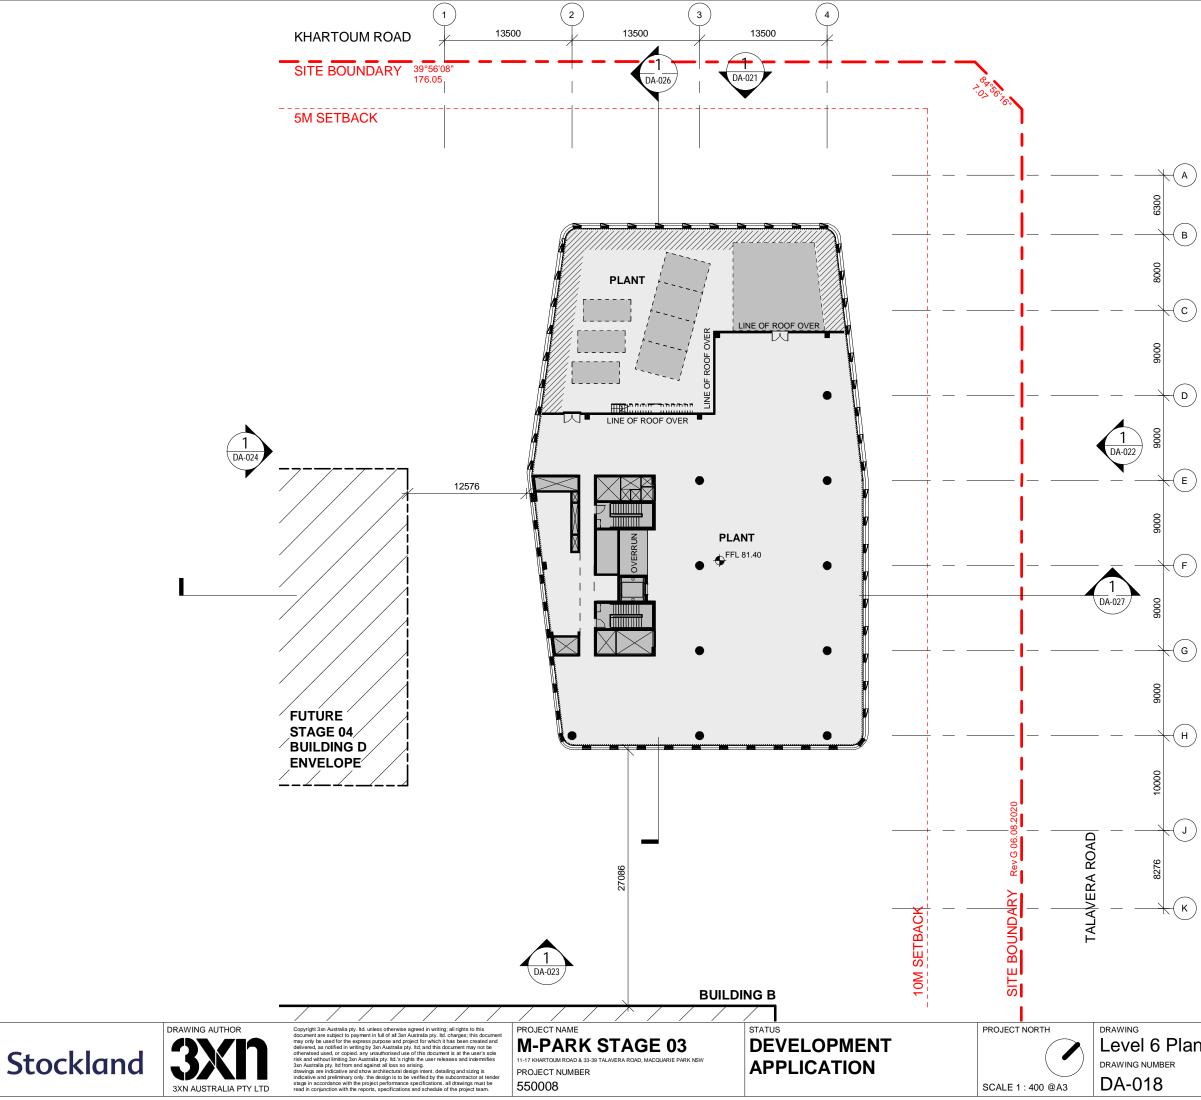


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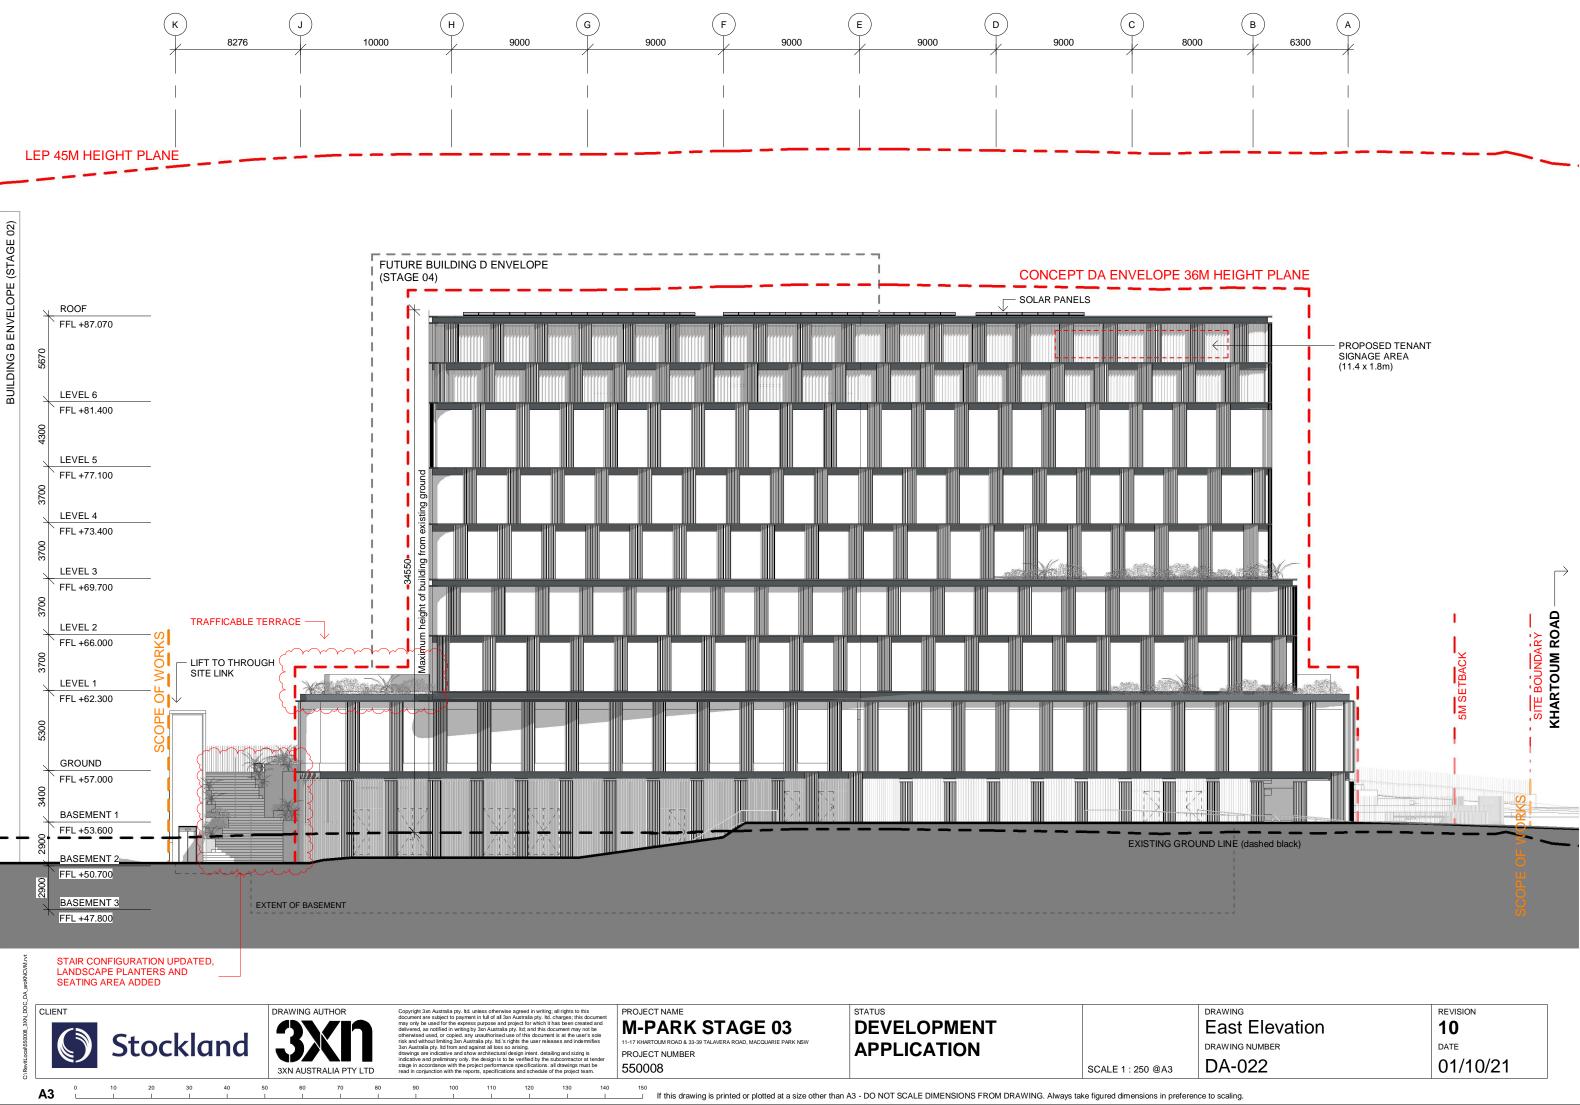
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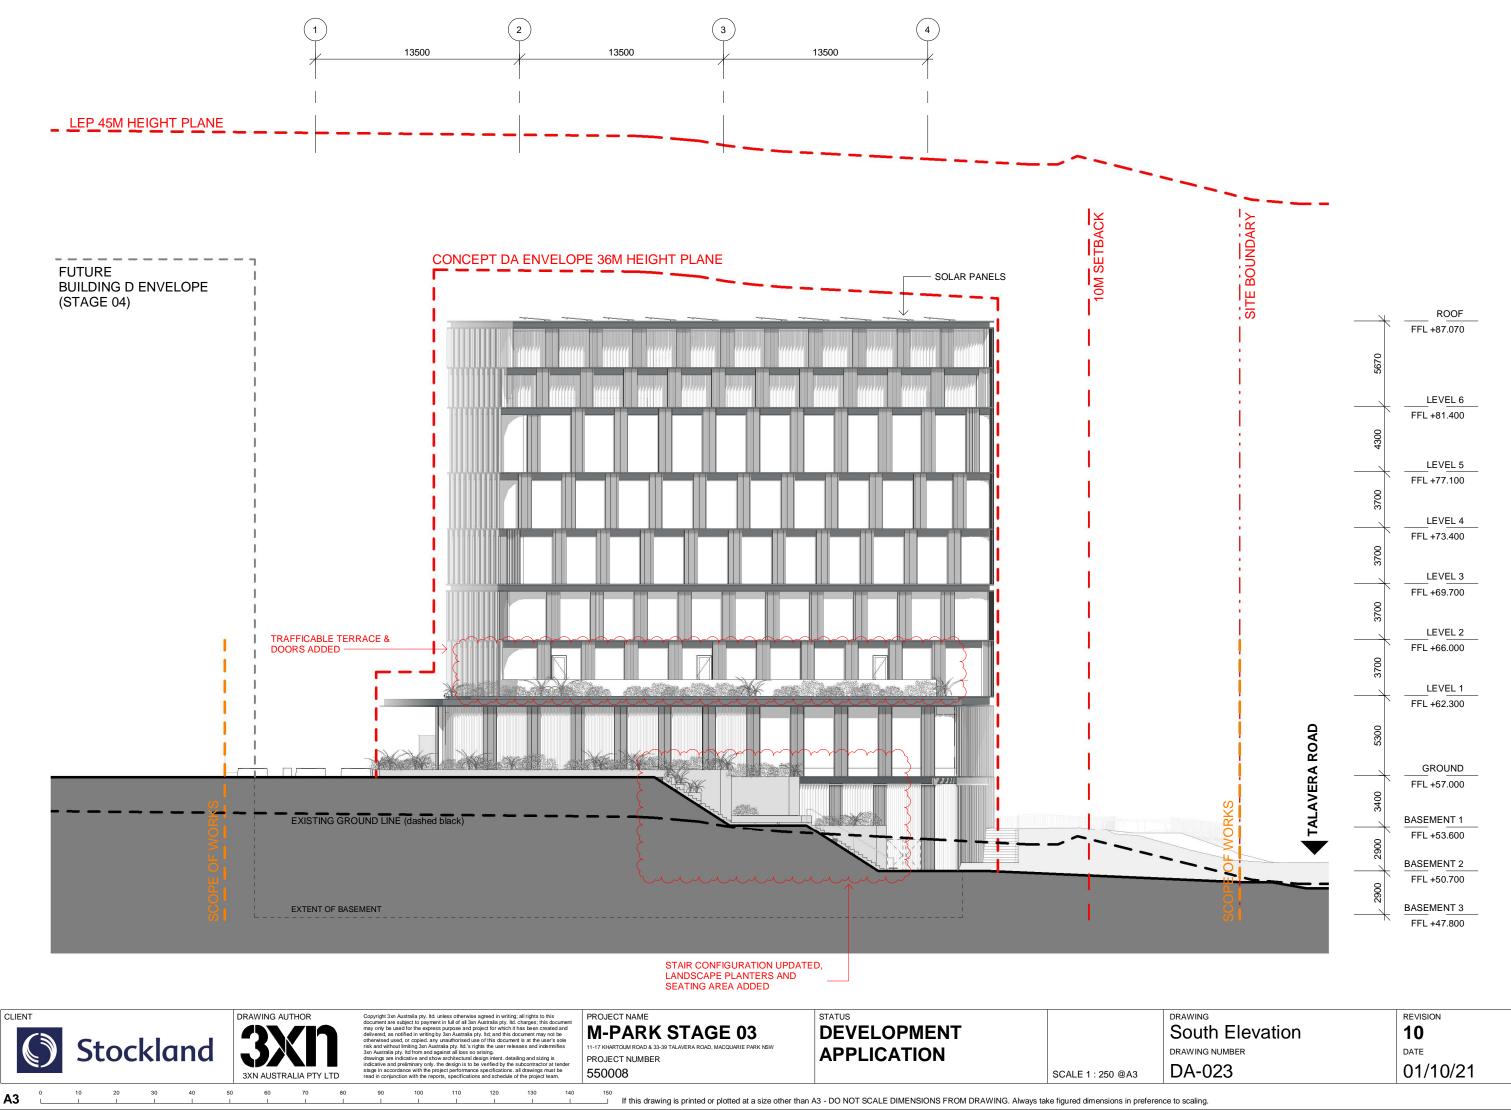
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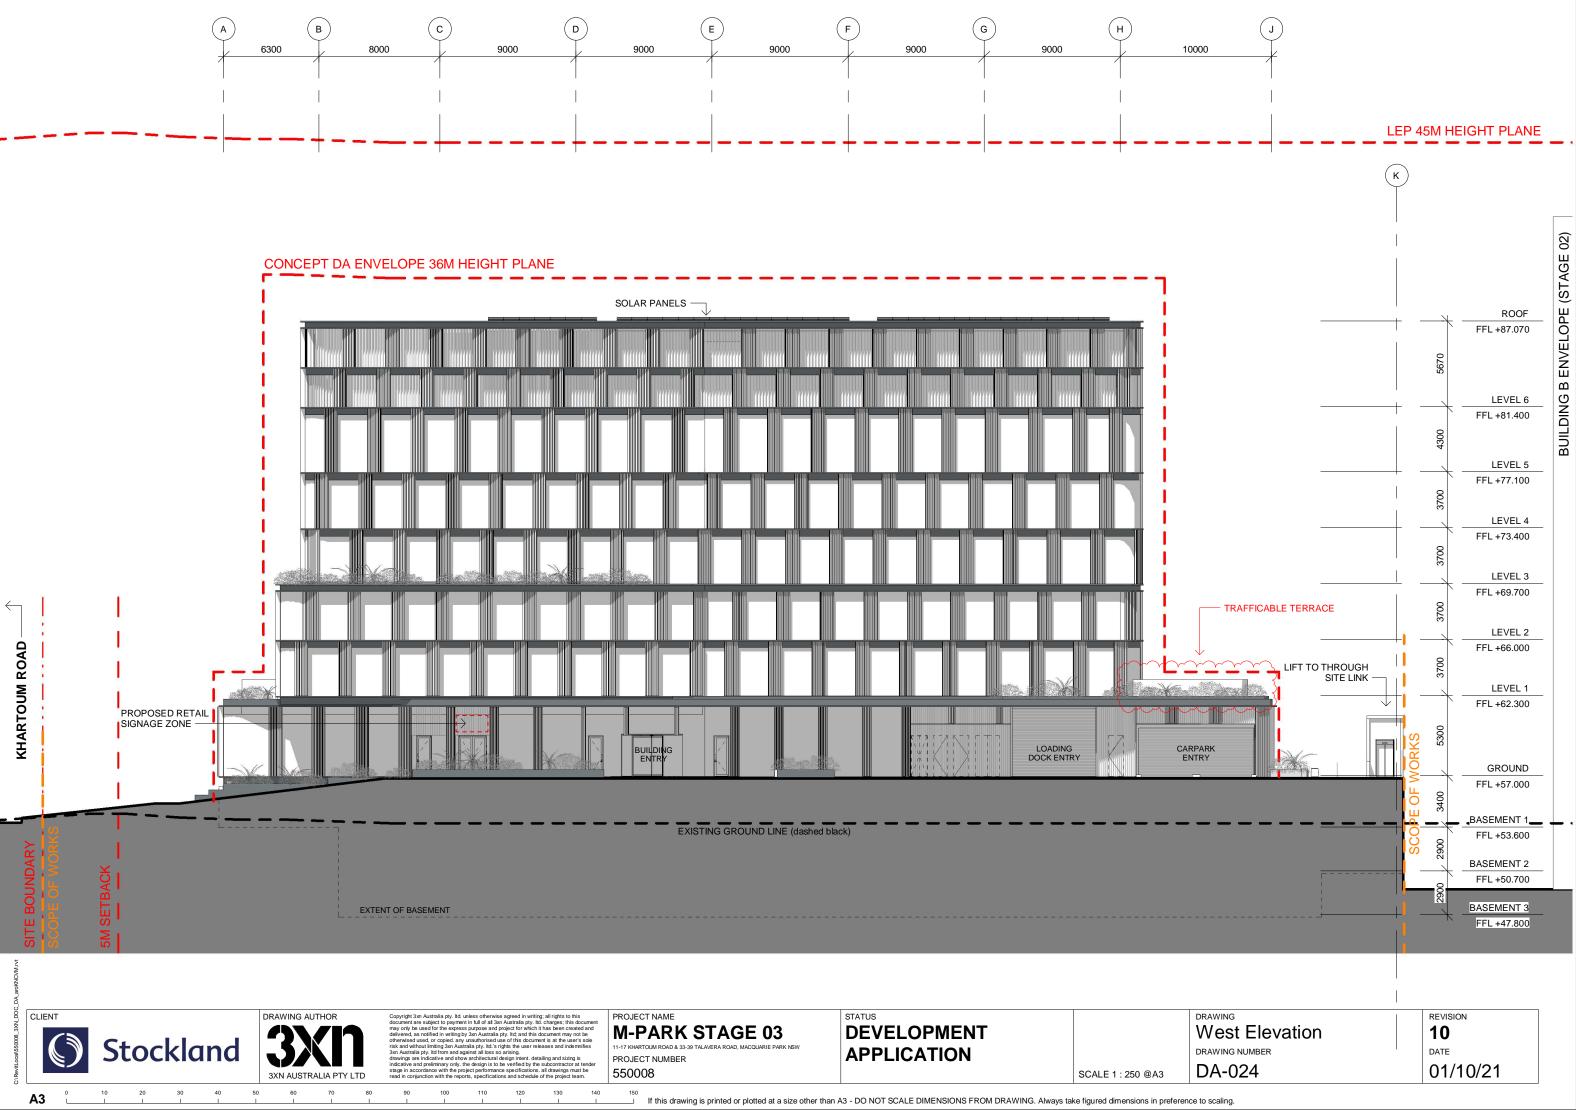
DRAWING	REVISION
Roof Plan	11
DRAWING NUMBER	DATE
DA-019	01/10/21

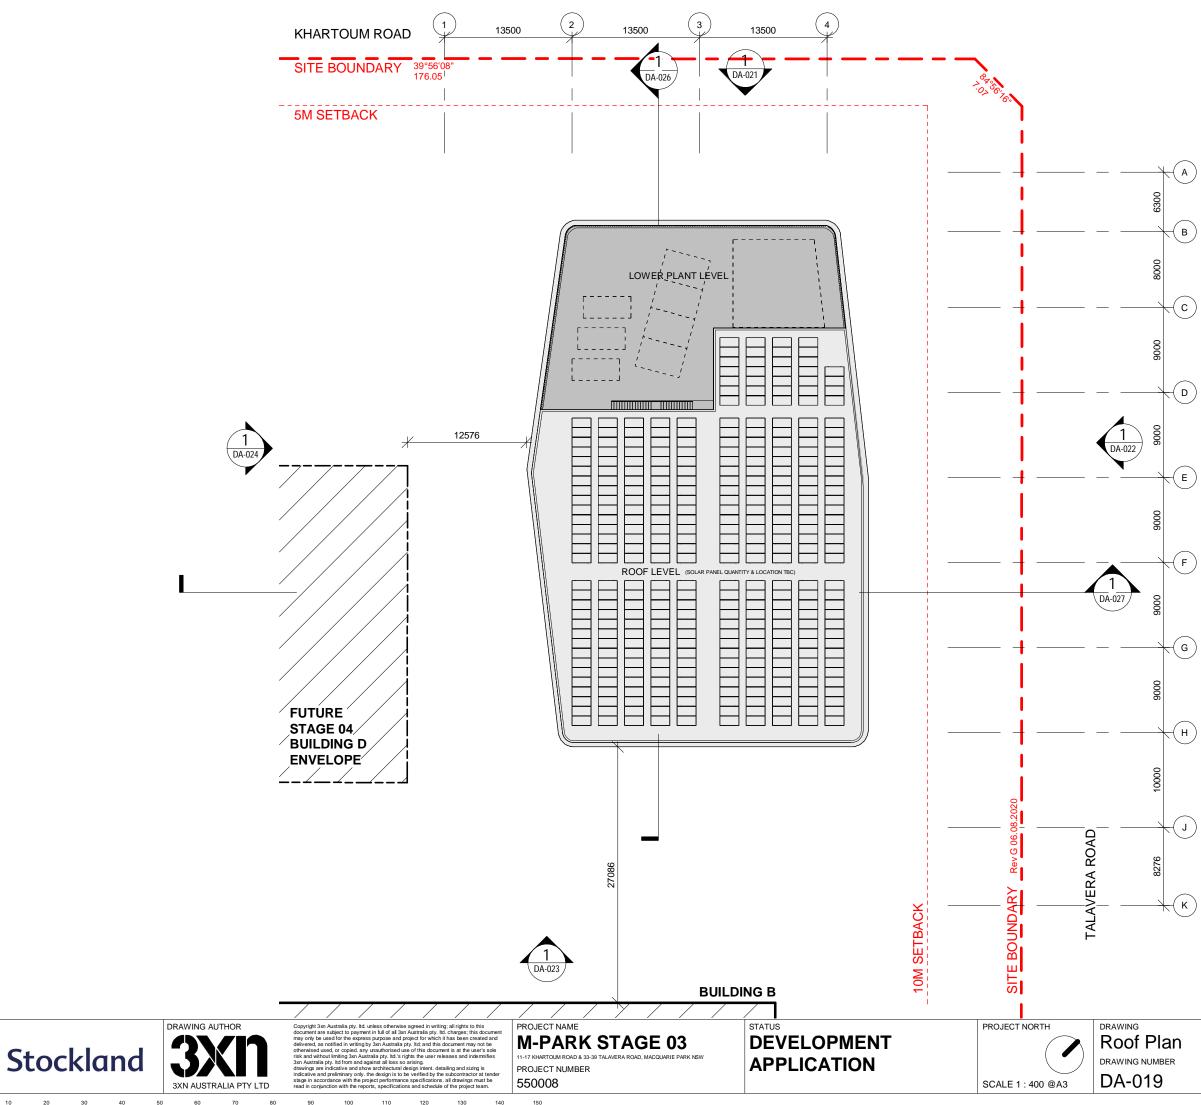


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LEP 45M HEIGHT PLANE



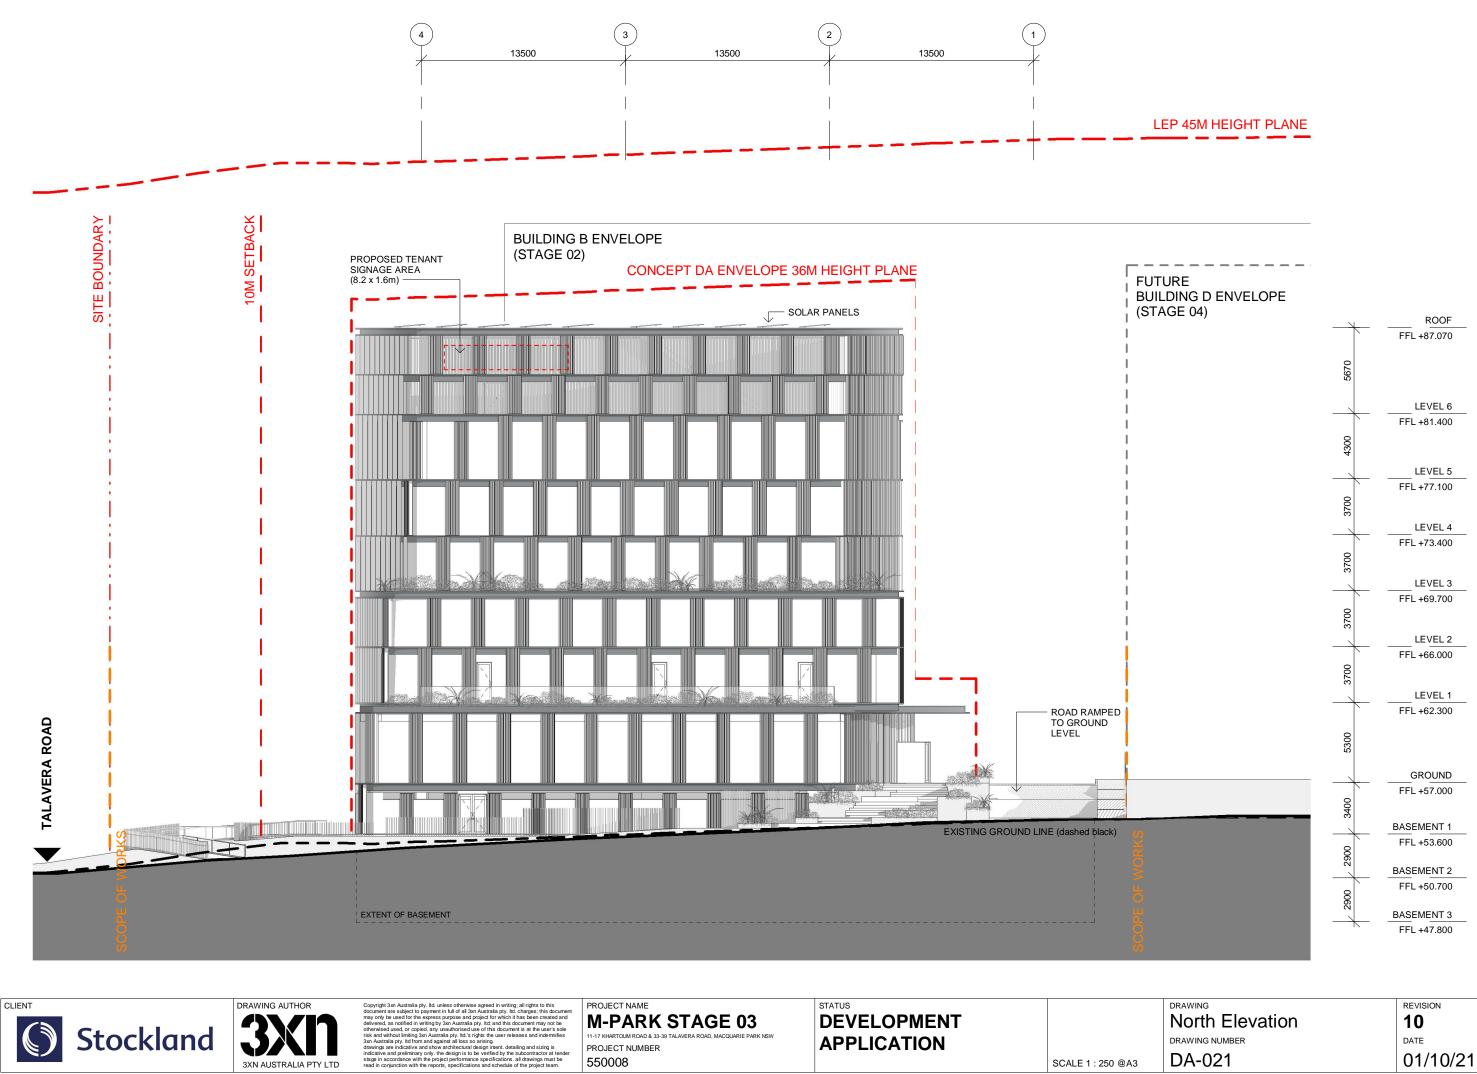

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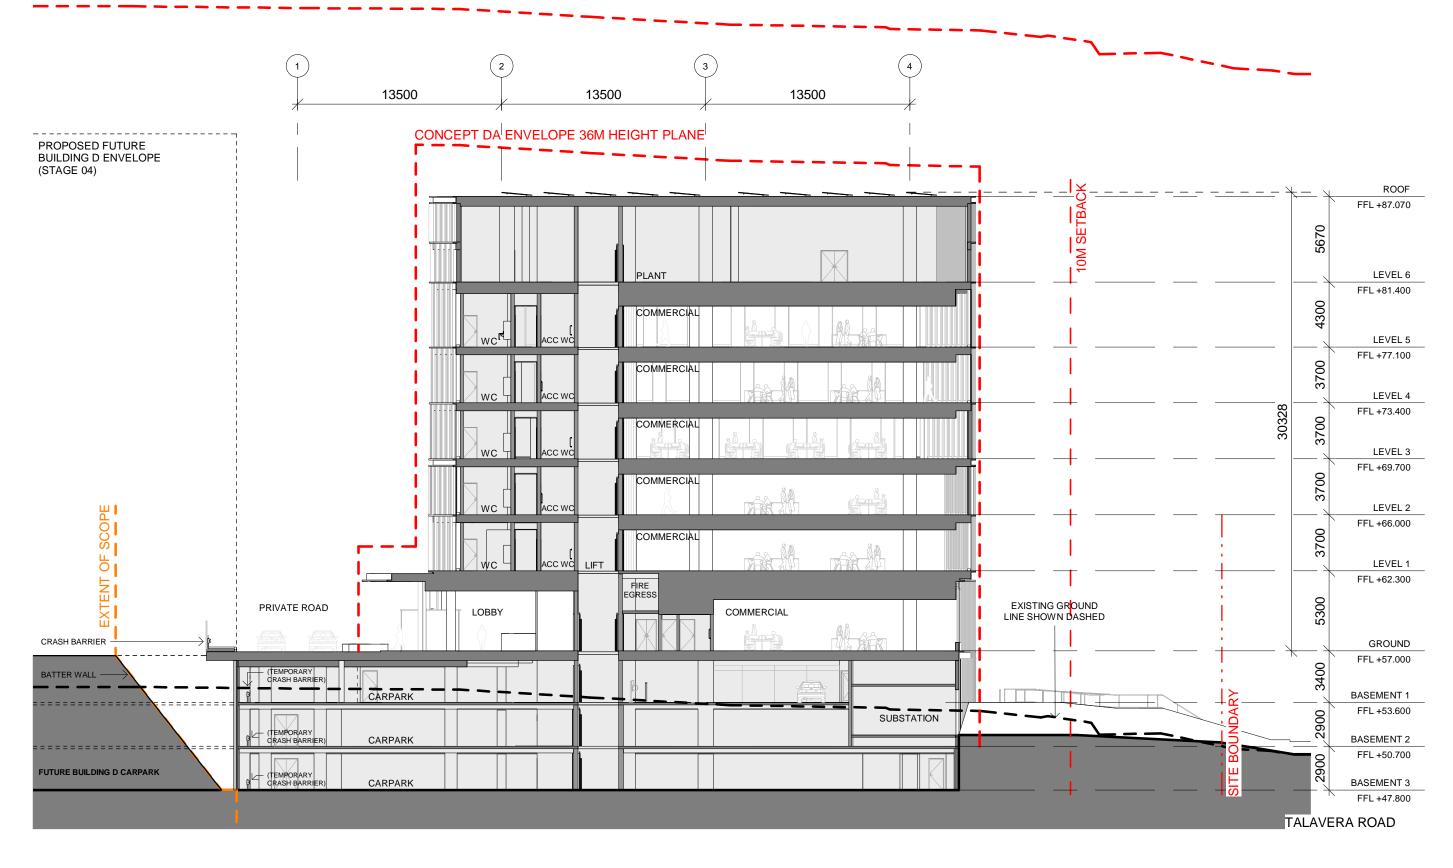
PROJECT NAME **M-PARK STAGE 03** 11-17 KHARTOUM ROAD & 33-39 TALAVERA ROAD, MACQUARIE PARK NSW PROJECT NUMBER 550008

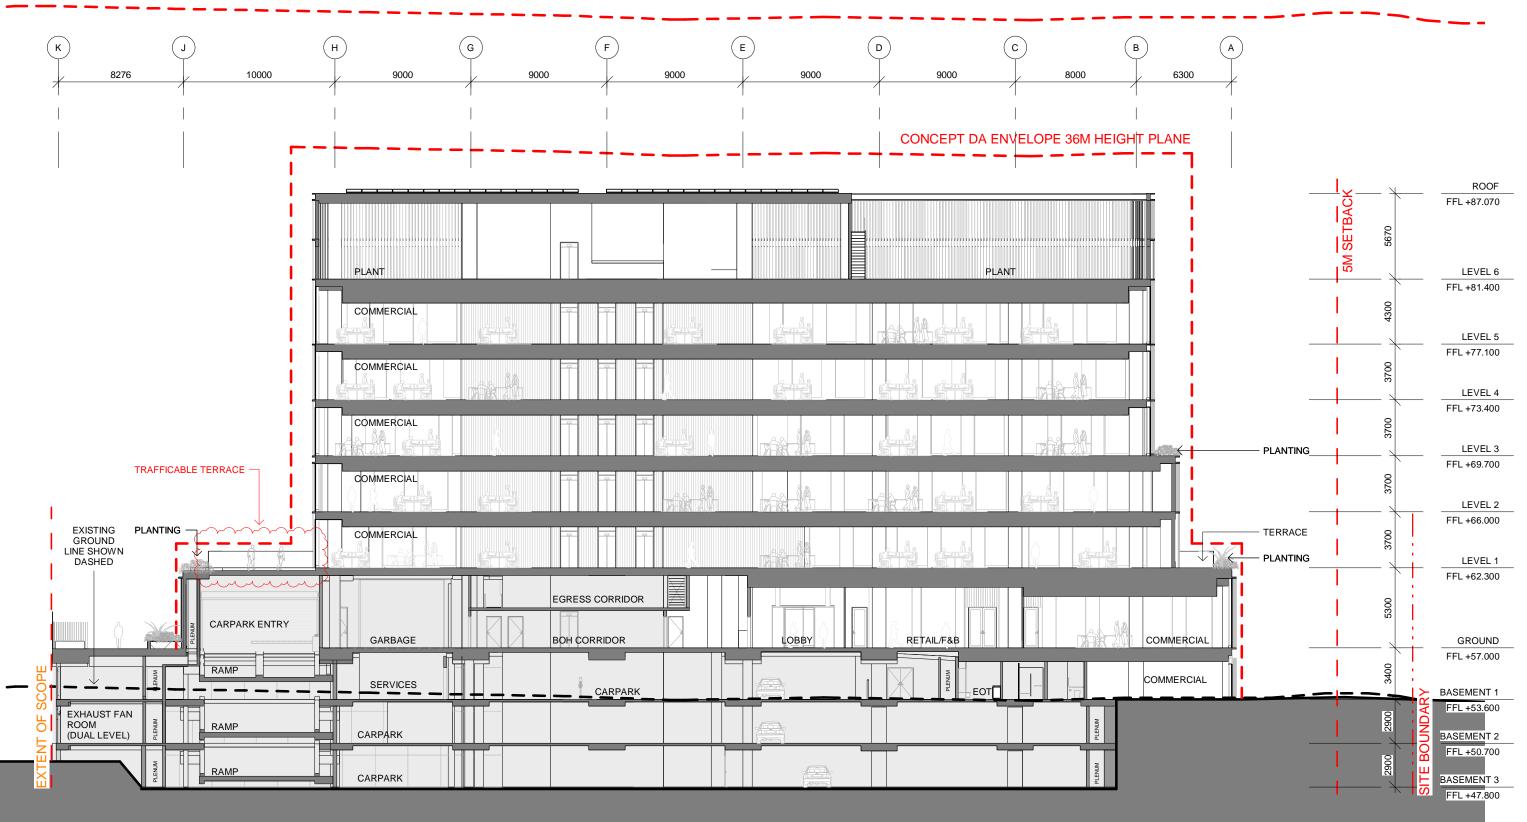

SCALE 1 : 250 @A3

DRAWING Section North-South	REVISION 11
DRAWING NUMBER	DATE
DA-026	01/10/21







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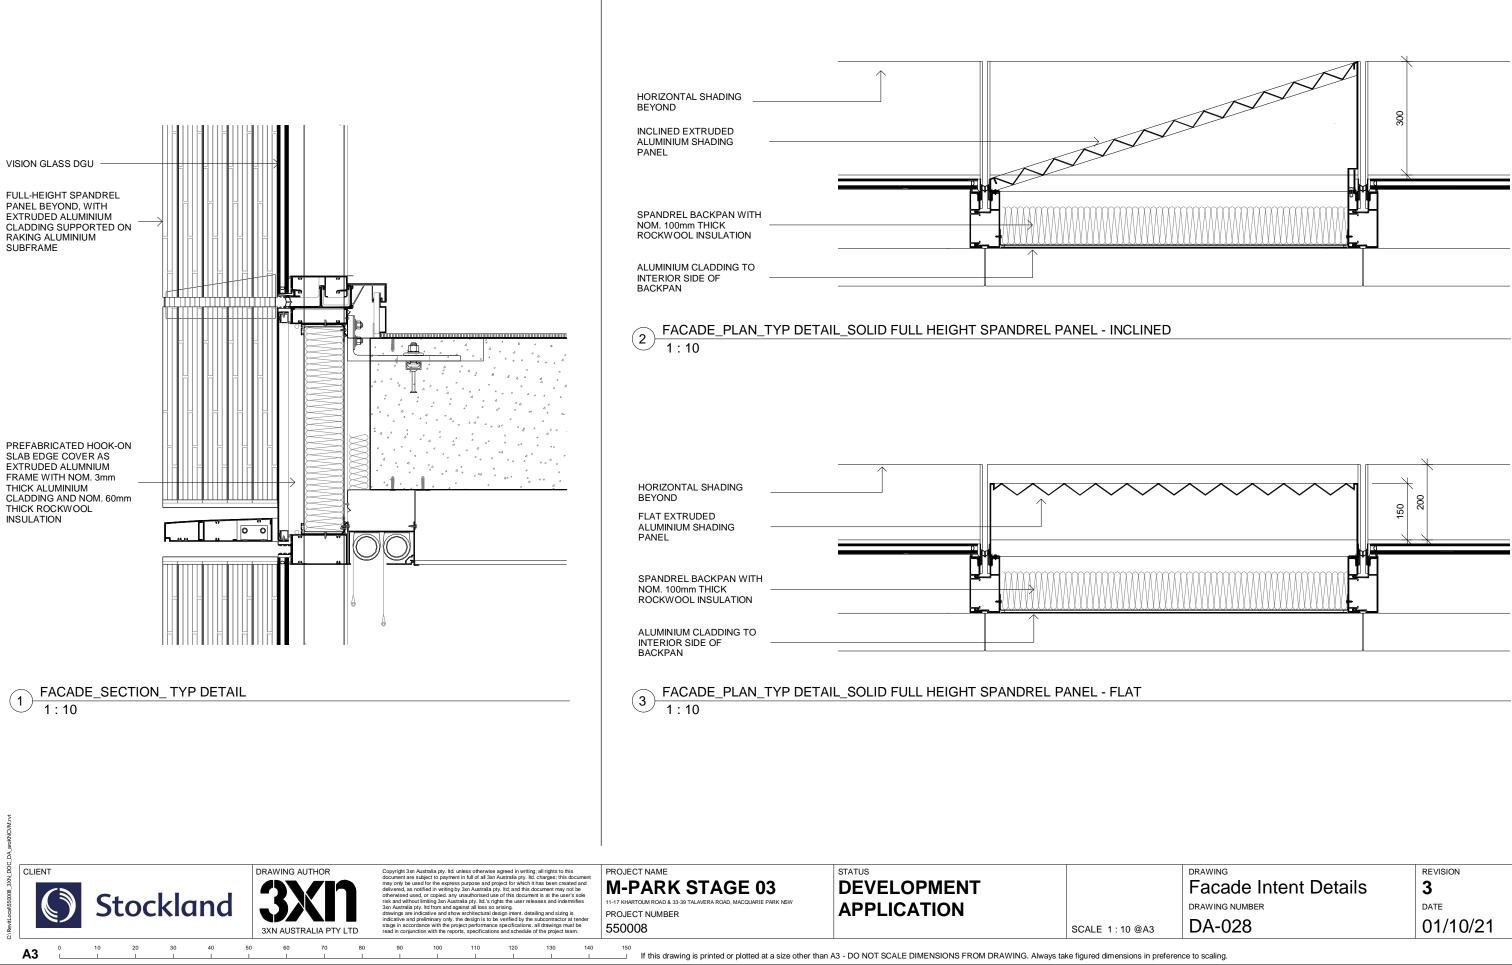
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PROJECT NAME **M-PARK STAGE 03** 11-17 KHARTOUM ROAD & 33-39 TALAVERA ROAD, MACQUARIE PARK NSV PROJECT NUMBER 550008








DRAWING	REVISION
Section East-West	11
DRAWING NUMBER	DATE
DA-027	01/10/21




DRAWING	REVISION
Facade Intent Details	3
DRAWING NUMBER	DATE
DA-028	01/10/21

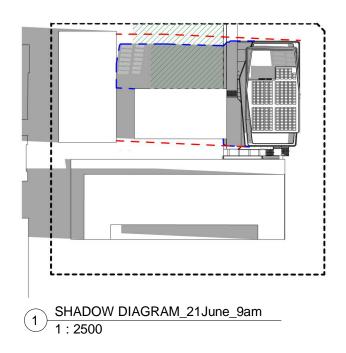

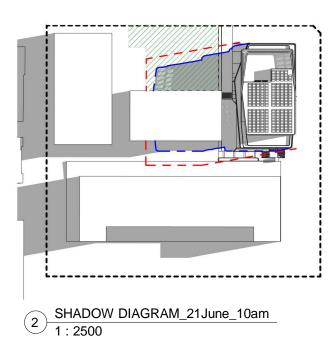

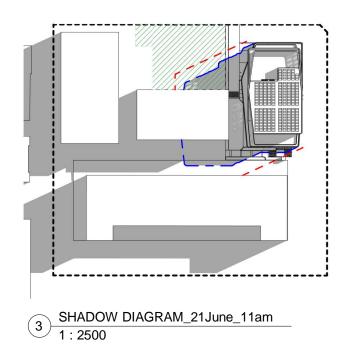

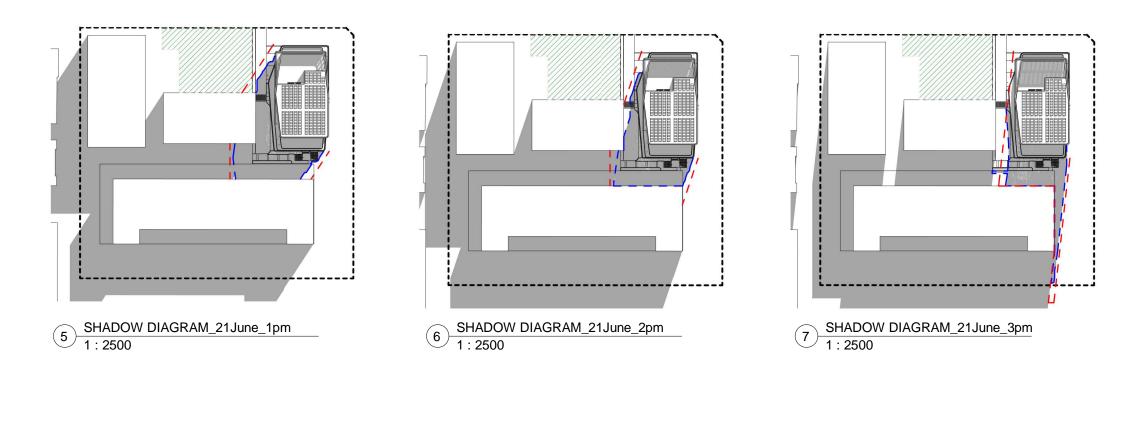


DRAWING AUTHOR CLIENT 3XN AUSTRALIA PTY LTD nay only I)Stockland


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PROJECT NAME M-PARK STAGE 03 1-17 KHARTOUM ROAD & 33-39 TALAVERA ROAD, MACQUARIE PARK NS PROJECT NUMBER 550008

STATUS DEVELOPMENT **APPLICATION**

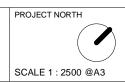


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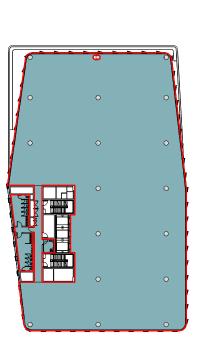
LEGEND


PUBLIC OPEN SPACE
 PROPOSED SHADOW OUTLINE
 45M MAX DEVELOPMENT SHADOW OUTLINE

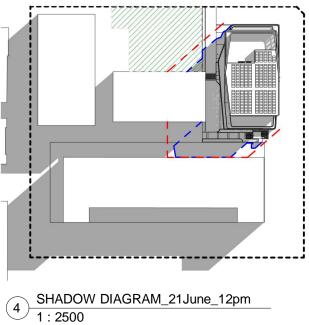DRAWING	REVISION
Shadow Diagrams	10
DRAWING NUMBER	DATE
DA-030	01/10/21




1 1:750

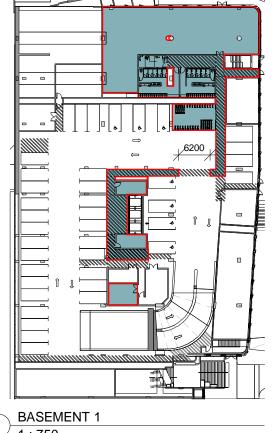


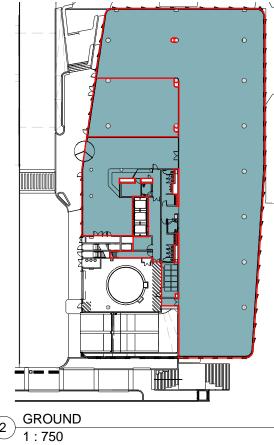



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3 LEVEL 1 1 : 750

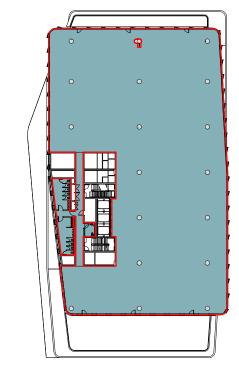



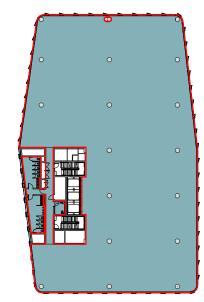

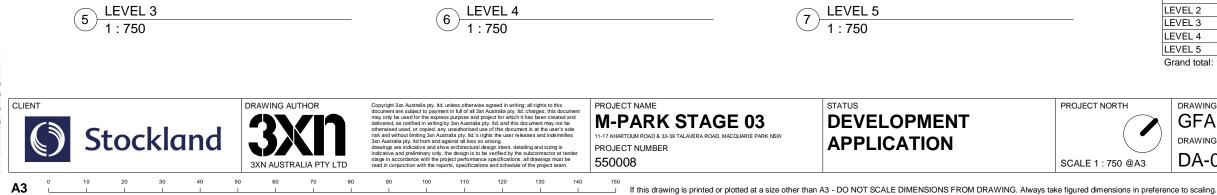LEVEL 2 1 : 750 4

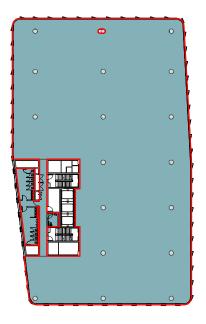Ryde Local Environmental Plan 2014

Gross Floor Area - means the sum of the floor area of each floor of a building measured from the internal face of external walls, or from the internal face of walls separating the building from any other building, measured at a height of 1.4 metres above the floor, and includes-

(a) the area of a mezzanine, and

(b) habitable rooms in a basement or an attic, and

(c) any shop, auditorium, cinema, and the like, in a basement or attic,

but excludes-

(d) any area for common vertical circulation, such as lifts and stairs, and
(e) any basement—
(i) storage, and

(i) vehicular access, loading areas, garbage and services, and
 (f) plant rooms, lift towers and other areas used exclusively for mechanical services


(y) planting, and
 (g) car parking to meet any requirements of the consent authority (including access to that car parking), and

(h) any space used for the loading or unloading of goods (including access to it), and

(i) terraces and balconies with outer walls less than 1.4 metres high, and (j) voids above a floor at the level of a storey or storey above.

Area Schedule (GFA)		
Area		
577 m²		
118 m ²		
24 m²		
1762 m ²		
200 m ²		
1759 m ²		
1800 m ²		
1674 m ²		
1674 m ²		
1674 m ²		
11261 m ²		

DRAWING	REVISION
GFA Area Plans	10
DRAWING NUMBER	DATE
DA-040	01/10/21

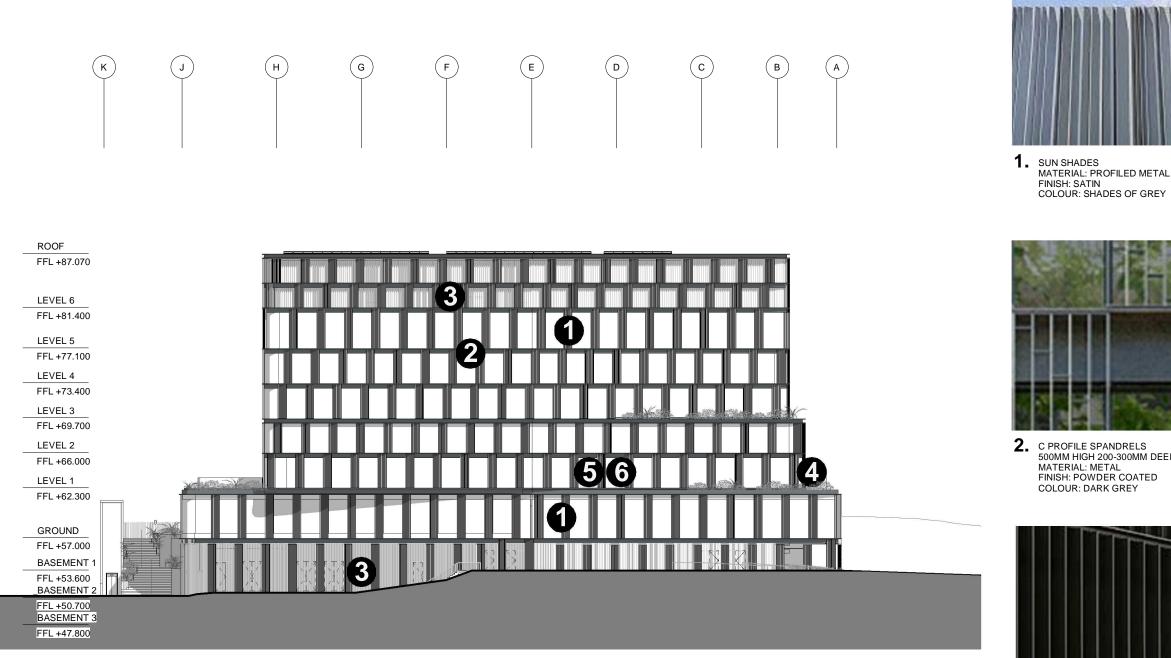





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PROJECT NAME **M-PARK STAGE 03** PROJECT NUMBER 550008





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A3

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4. FRAMELESS BALUSTRADE MATERIAL: GLASS COLOUR: CRYSTAL CLEAR



C PROFILE SPANDRELS 500MM HIGH 200-300MM DEEP (VARIES)



5. HIGH PERFOMANCE GLAZING COLOUR: CRYSTAL CLEAR



6. MULLIONS MATERIAL: METAL FINISH: POWDER COATED COLOUR: DARK GREY

M Park Building C Landscape Development Application

Drawing Schedule

Drawing Number	Drawing Title	Scale	Revision
000	Landscape Coversheet	N/A	Е
001	Landscape Plan	1:250	Е
101	Landscape Plan	1:100	Е
102	Landscape Plan	1:100	Е
011	Landscape Plan Level 1 & 3	1:200	D
501	Landscape Details & Planting Schedule	As Shown	D
502	Landscape Details & Planting Schedule	As Shown	D
601	Landscape Sections	As Shown	D
701	Deep Soil Plan	1:250	С

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The contractor shall check and verify all work on site (including work by others) before commencing the landscape installation. Any discrepancies are to be reported to the Project Manager or Landscape Architect prior to commencing work. Do not scale this drawing. Any required dimensions not shown shall be referred to the Landscape Architect for confirmation.

Revised for Council Comments Revised for Council Comments Revised for Comments Civil Coordination A For Comment Issue Revision Description


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LEGEND



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Site Plan | Scale 1:500
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Key Plan:

Stockland

M Park Building C

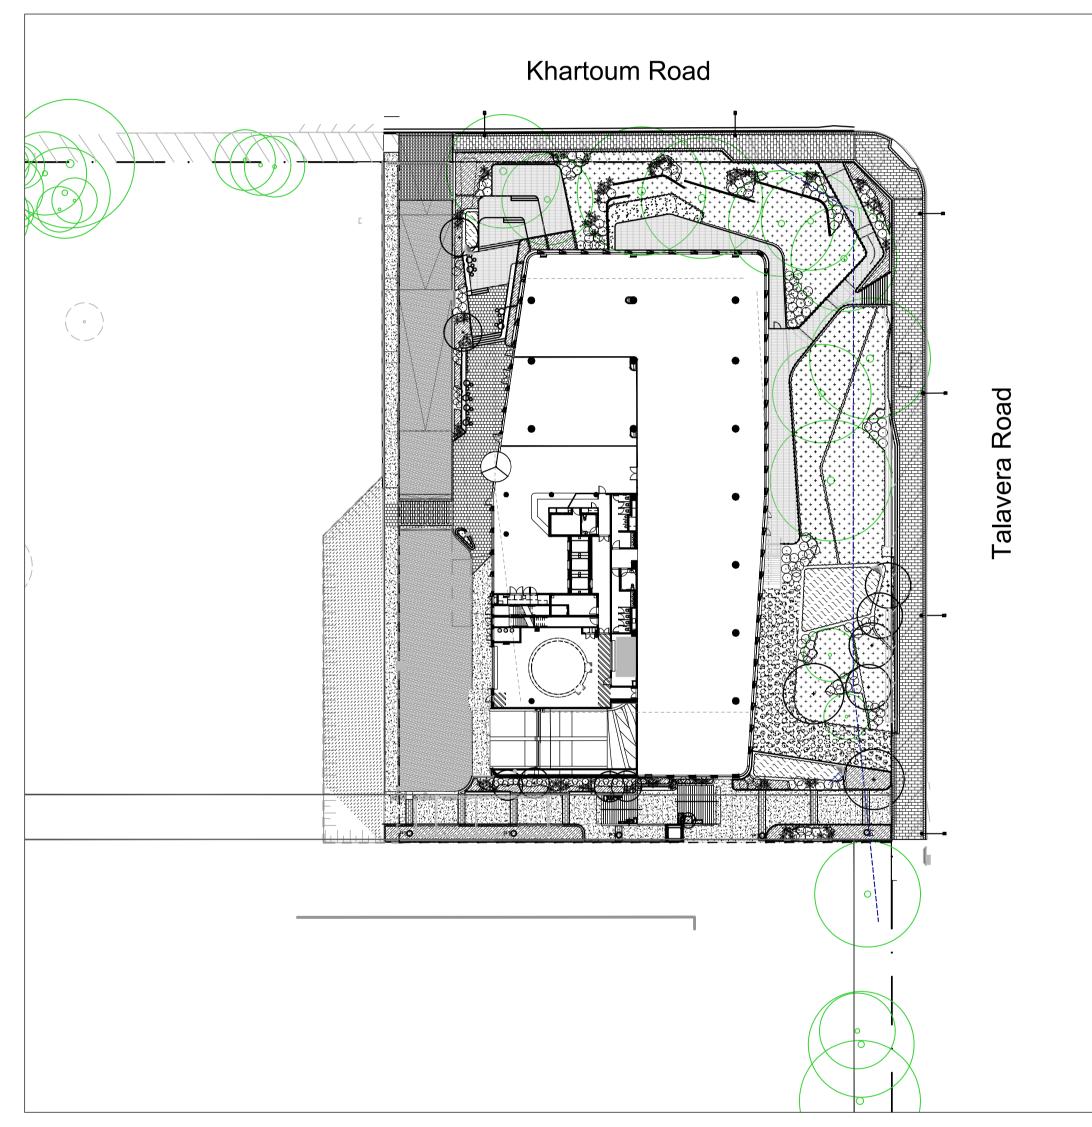Drawing Name: Landscape Coversheet

DEVELOPMENT APPLICATION

Scale: Job Number: SS20-4495

Drawing Number:

Issue: 000 E




Entry retail dining and seating area. Vegetative buffer to driveway edge



Terrace with seating edges. Planting to building and driveway edges for visual seperation and privacy



'Floating' platforms to Khartoum road. Suspended terraces lowering down to Khatroum Road, Terraces to feature a variety of built in informal seating.

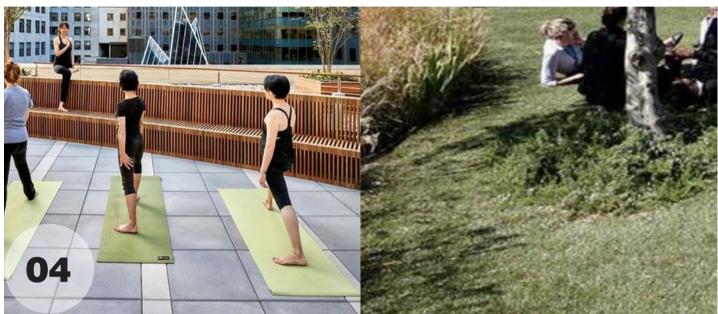

Wellness terrace - breakout space with adjoining lawn area. Privacy screening within Khartoum Road frontage setback.



Accessible path into basement level from Khartoum road, Talavera Rd frontage. Suspended over existing ground conditions and tree protection zones



Talavera Road frontage planting, under story planting to existing trees



Through site link stairs with garden bed to building

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Response to Council Revised for Council Comments Revised for Comments Civil Coordination A For Comment Issue Revision Description

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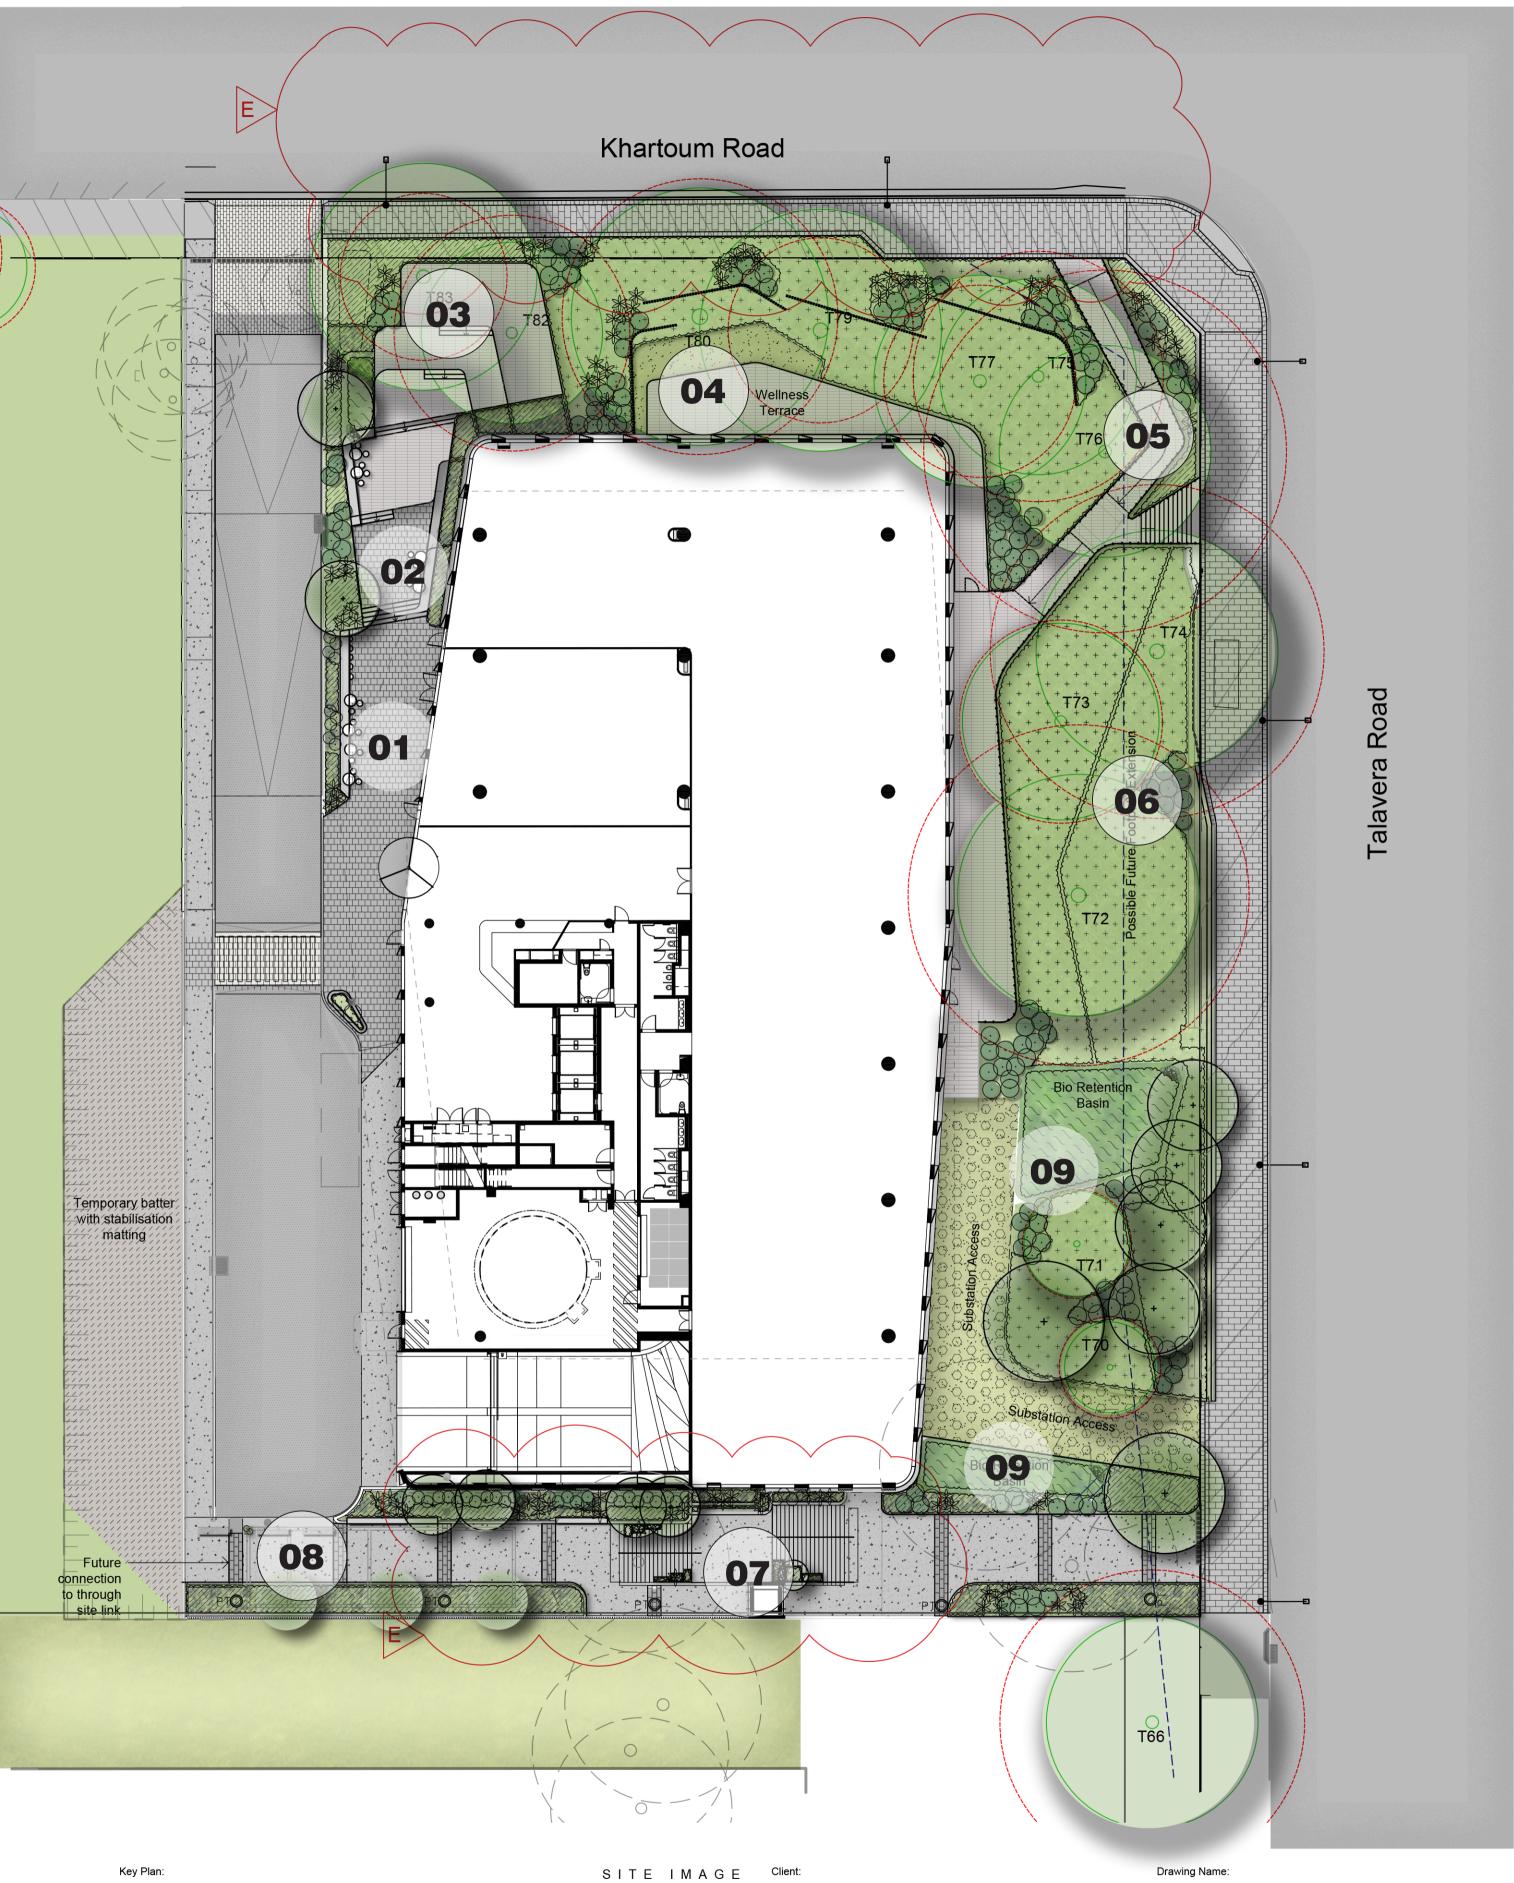





Through site link, paved pedestrian link to join to future stages to the south east

			LEGE	ND		
				Property Boundary		Asphalt Refer to Civil Docume
				Existing Tree to be retained	4 4 4 4 4	Concrete
			·	Existing Tree to be removed		Unit Paving
JD	NM	01.10.2021	(\cdot)	Proposed Tree Refer to planting schedule		Suspended Paving
JD	NM	13.05.2021	CITTIN S	Planting Type 1		Public Domain Paving
JD	NM	16.12.2020	Lulit			To council standards
JD JD	NM NM	14.12.2020 17.11.2020	+ + + +	Planting Type 2		Public Domain Crosse To council standards
Drawn	Check	Date				

Bio Retenion basins with native species



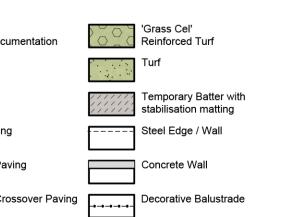



Bio Retention Basin planting



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Building C

Stockland

Project: M Park

DEVELOPMENT APPLICATION

^{Scale:} 1:250 @ A1 Job Number: SS20-4495


Landscape Plan

Ground Floor / B1

Drawing Number:

001 E



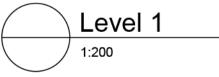

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Revised for Comments D Revised for Comments С B Civil Coordination A For Comment Issue Revision Description

LEGEND



JD NM 01.10.2021

JD NM 16.12.2020

JD NM 14.12.2020

JD NM 17.11.2020

Drawn Check Date

Planter Bed with Liner Refer detail and planting schedule

Maintenance access area

Key Plan:



1:200



Stockland

Project: M Park Building C


Drawing Name: Landscape Plan Level 1 & 3

DEVELOPMENT APPLICATION

^{Scale:} 1:200 @ A1 Job Number: SS20-4495

10m Drawing Number: Issue:

011 D

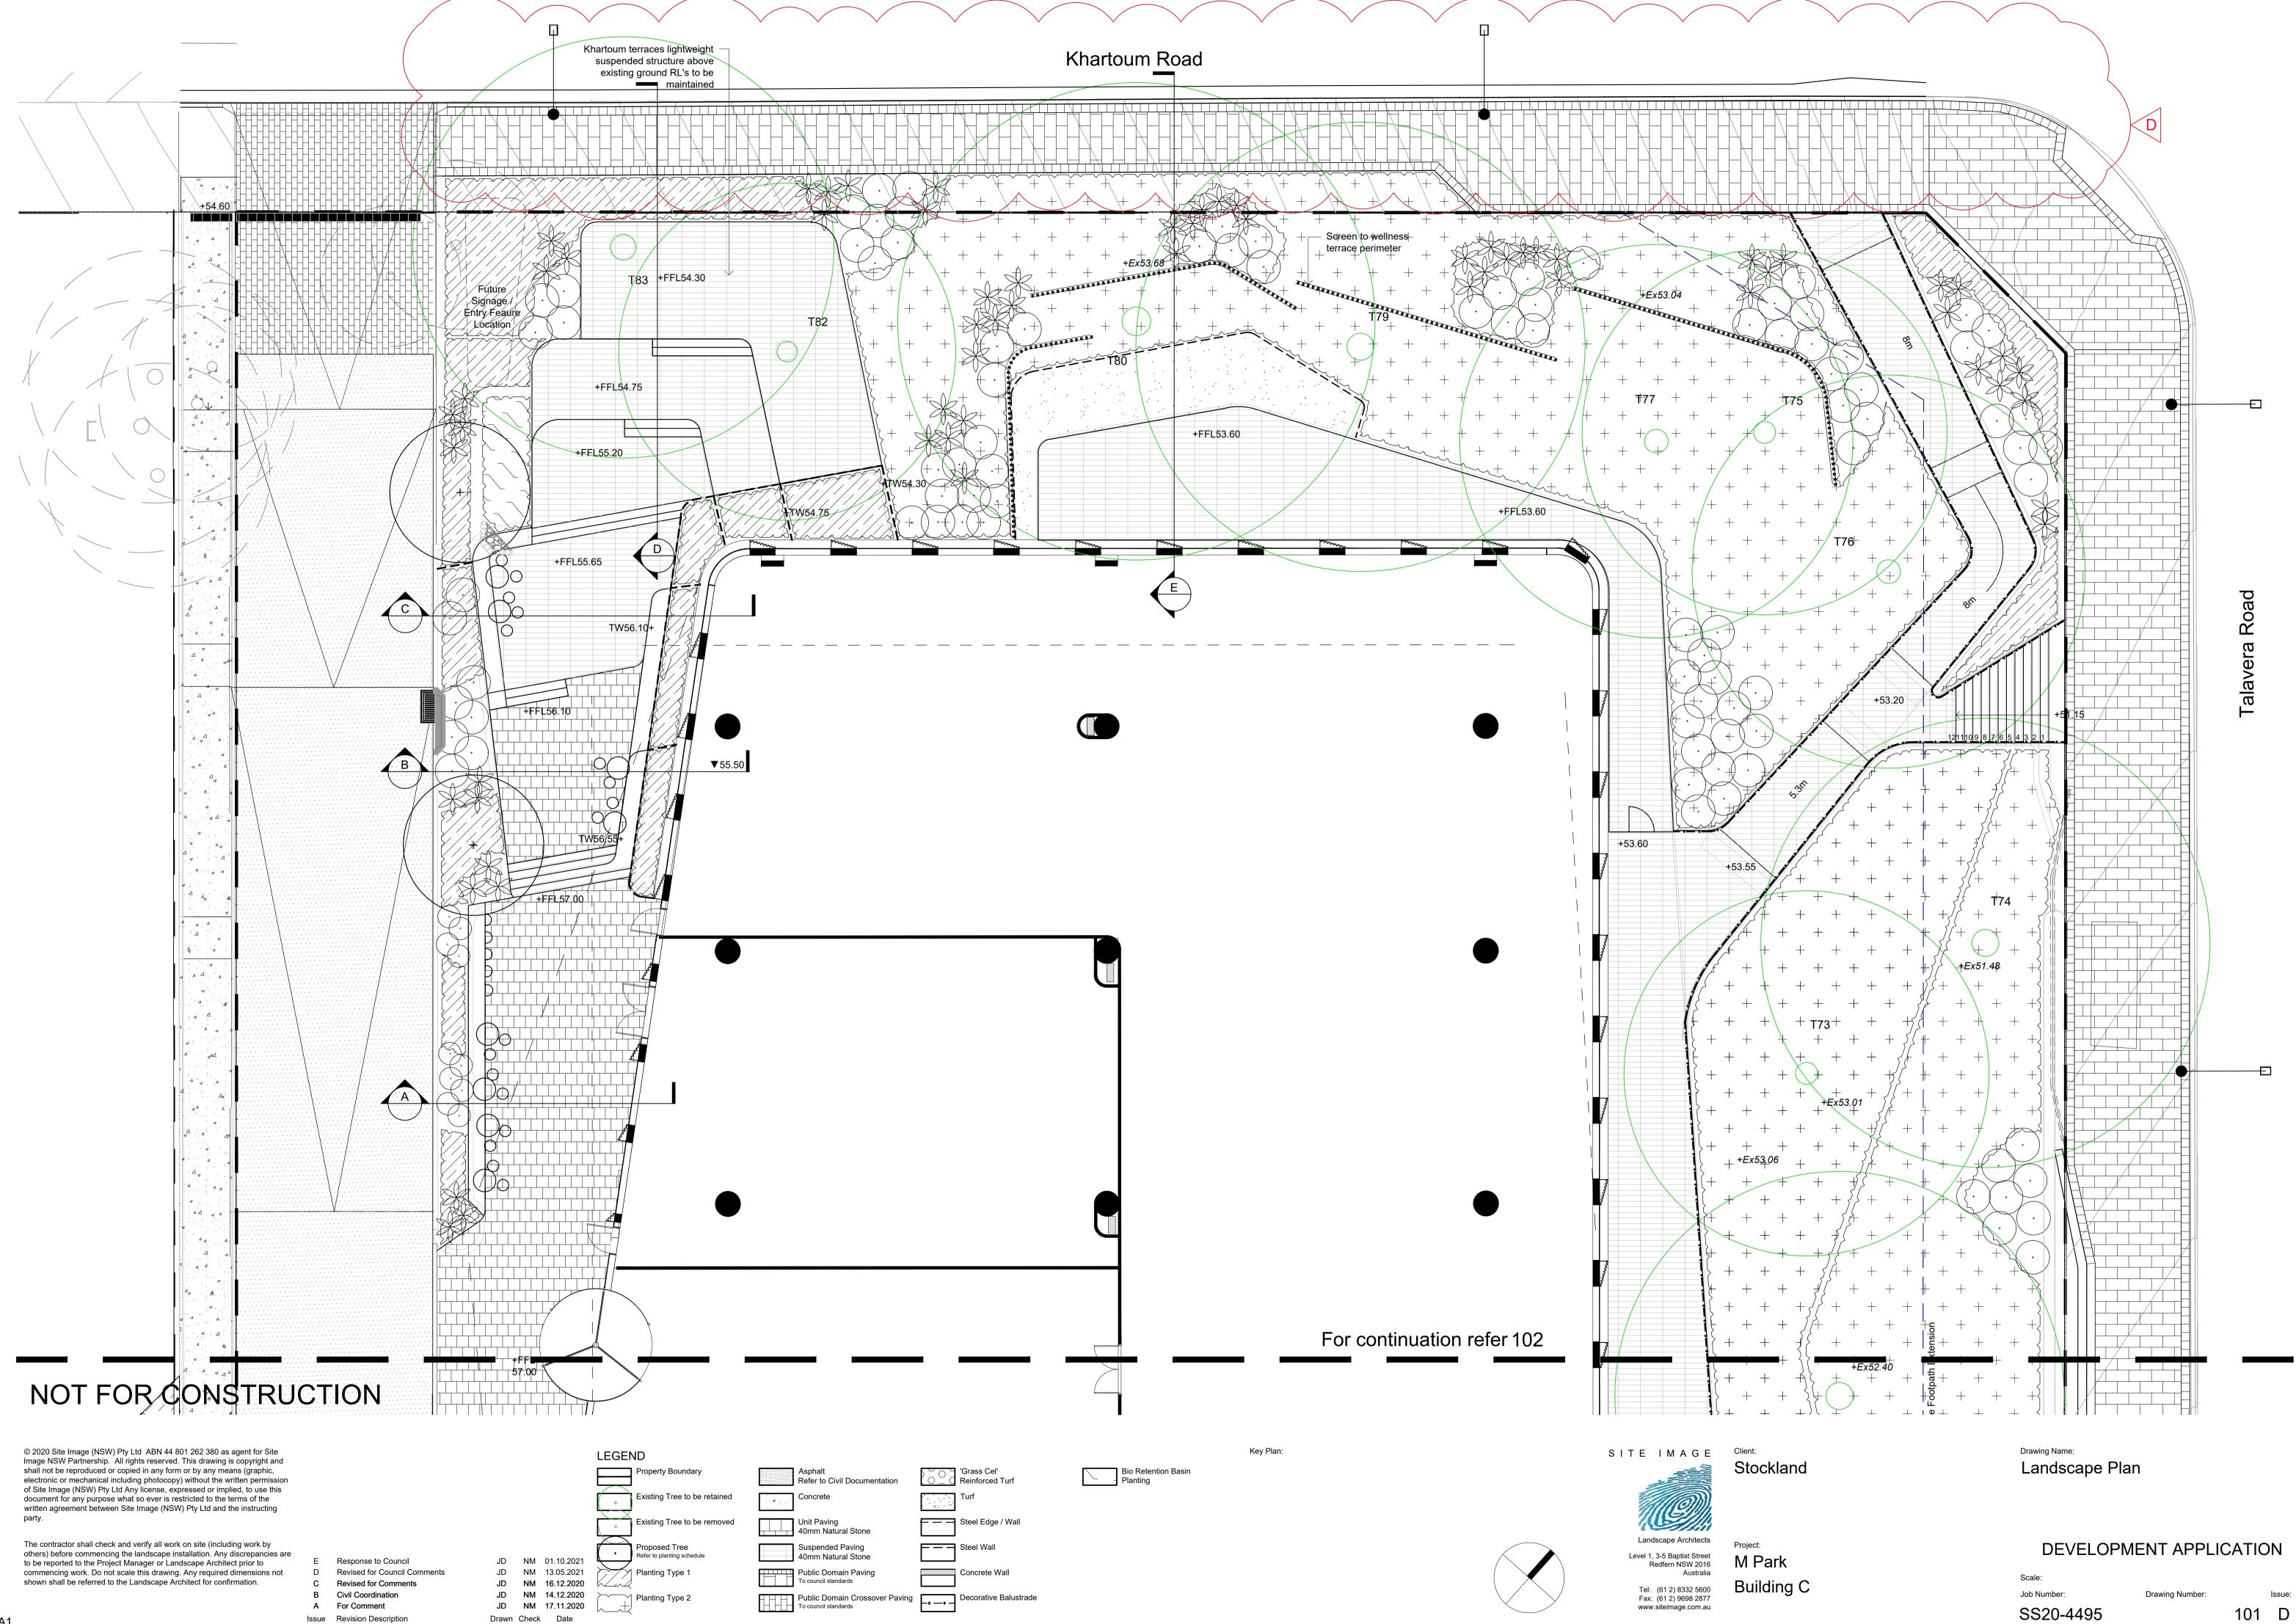

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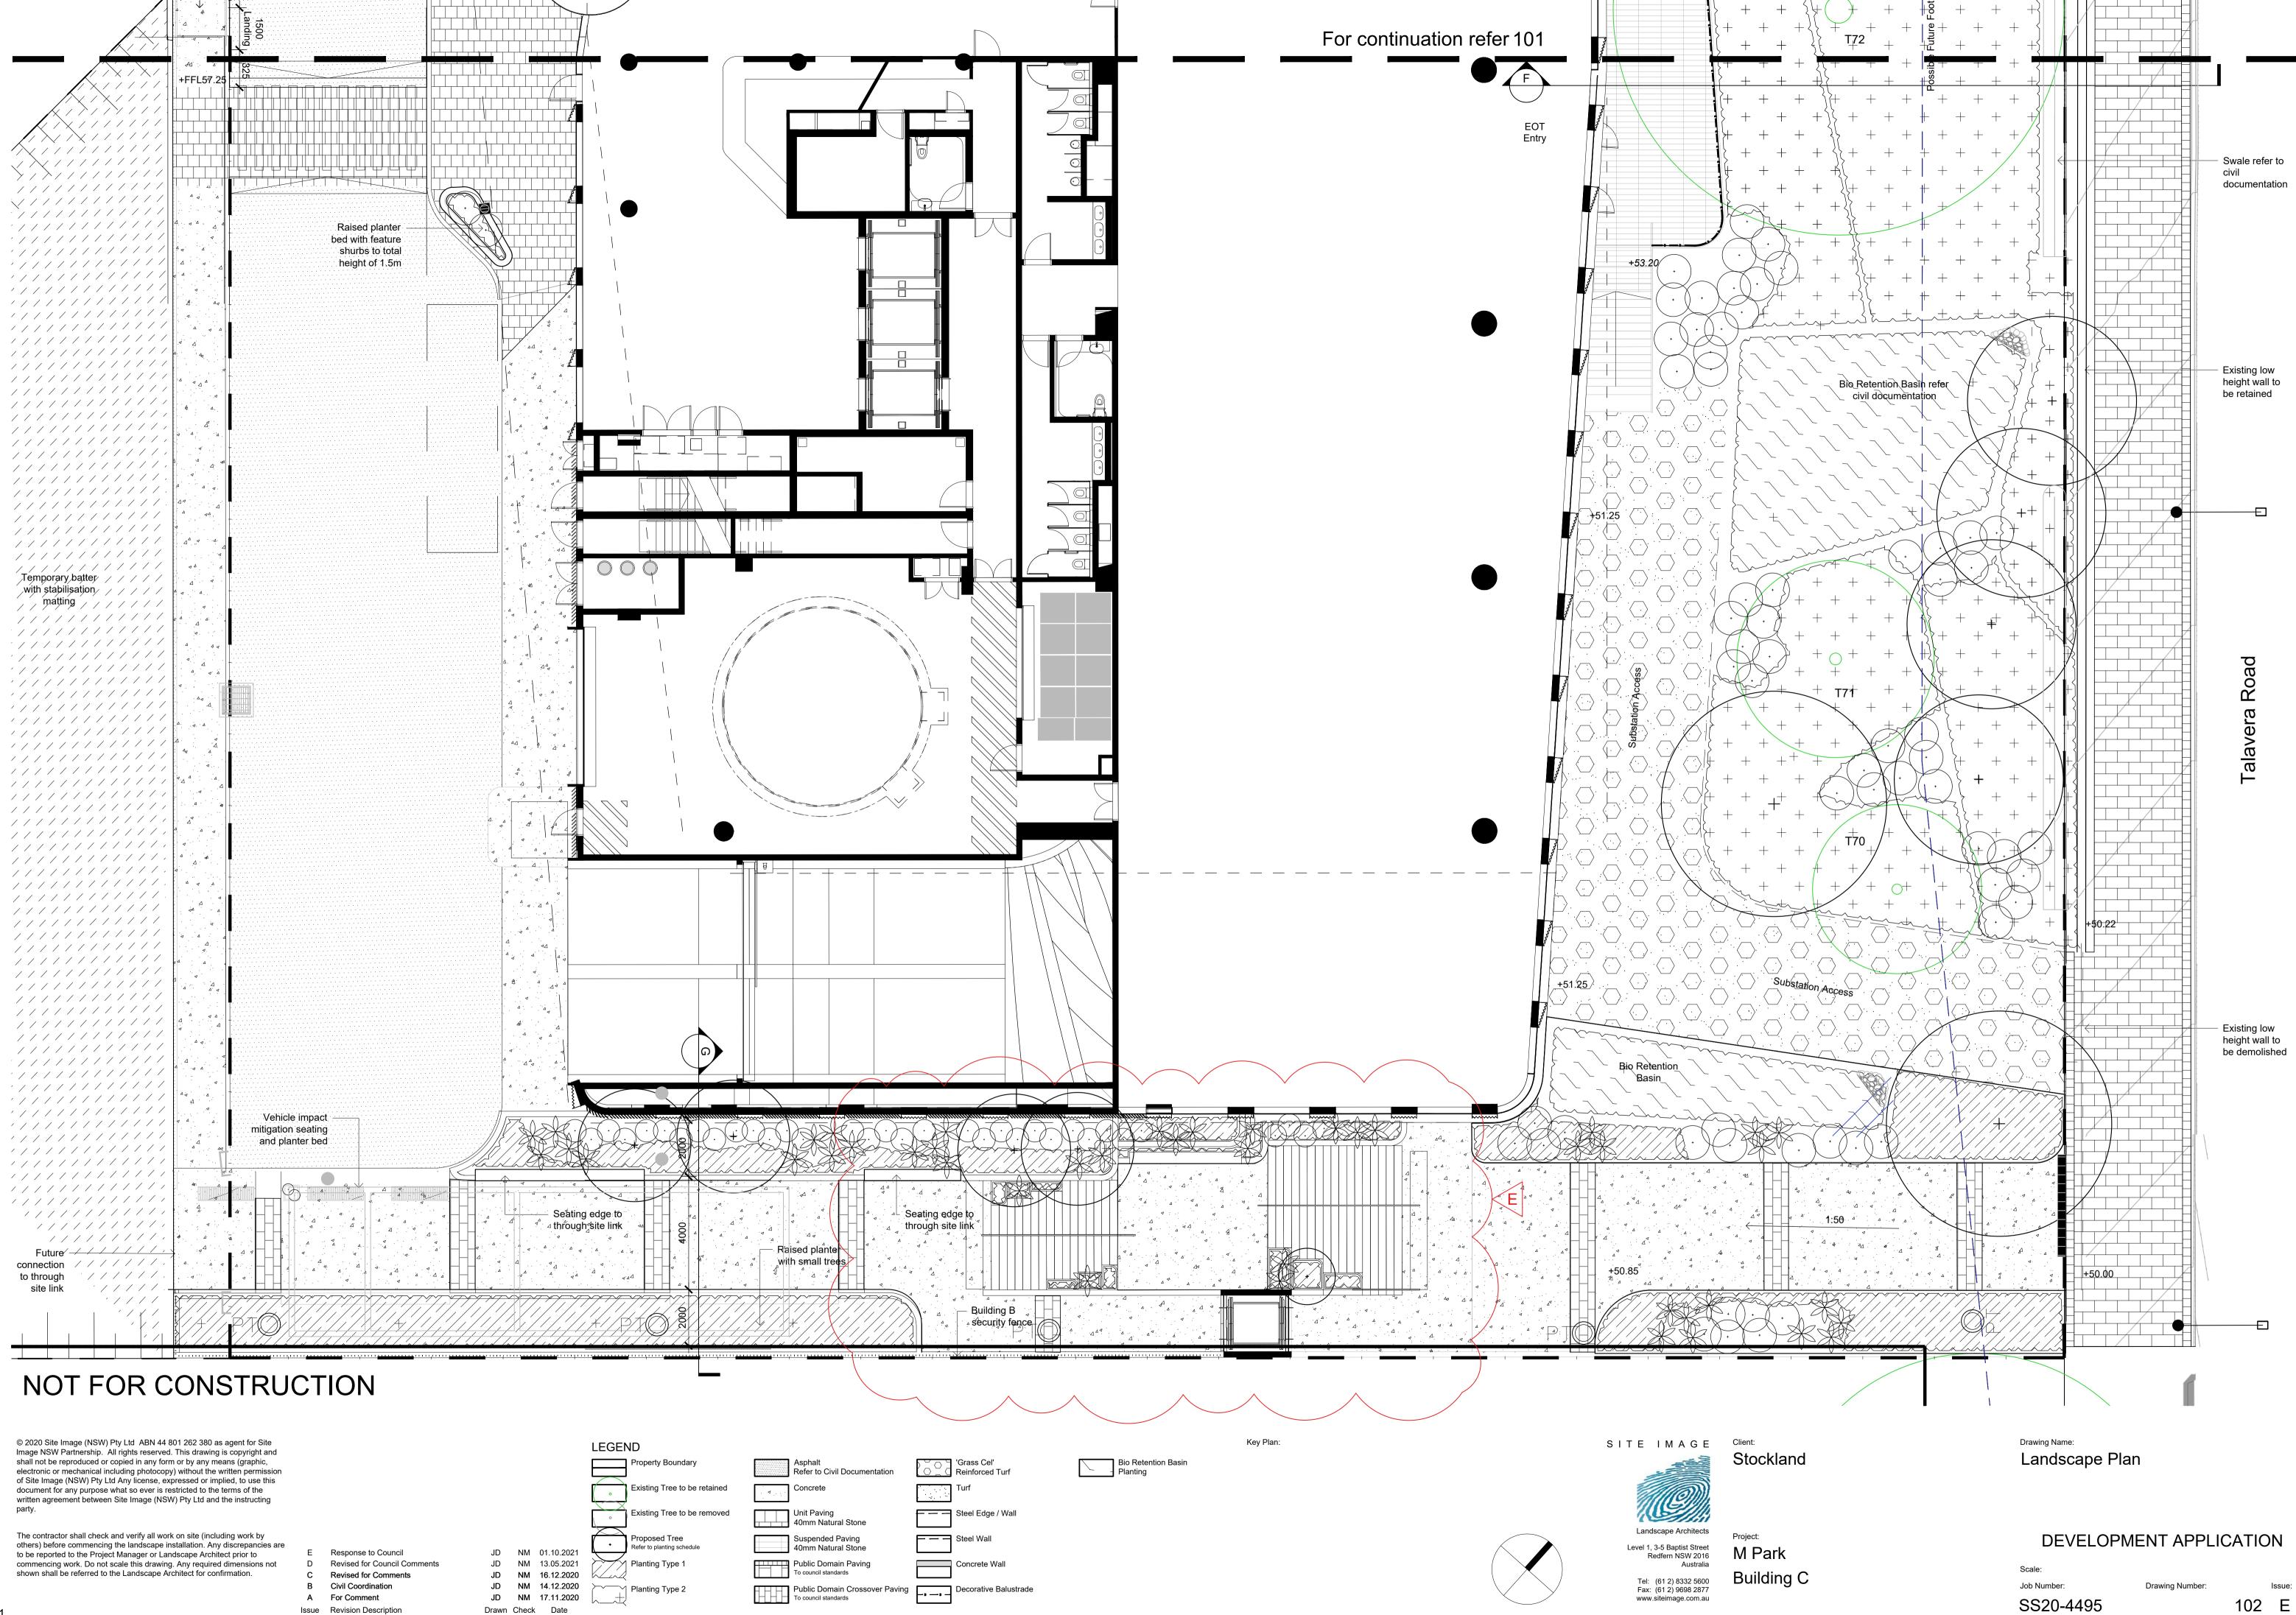
Е	Response to Council
D	Revised for Council Comr
C.	Revised for Comments

3	Civil Coordination	
4	For Comment	

JD	NM	01.10.2021	
JD	NM	13.05.2021	
JD	NM	16.12.2020	
JD	NM	14.12.2020	
JD	NM	17.11.2020	
Drown	Chock	Data	

Ν	ID	
]	Property Boundary	
	Existing Tree to be retained	4
Ì	Existing Tree to be removed	
)	Proposed Tree Refer to planting schedule	
1	Planting Type 1	
1	Planting Type 2	

SS20-4495




Е	Response to Council
D	Revised for Council Comm
С	Revised for Comments
В	Civil Coordination
Α	For Comment

	Property Boundary	
	Existing Tree to be retained	[
	Existing Tree to be removed	[
1.10.2021	Proposed Tree Refer to planting schedule	
3.05.2021	Planting Type 1	F
6.12.2020	h	L
1.12.2020	Planting Type 2	F
7.11.2020		L
Data		

	Asphalt Refer to Civil Docur
4	Concrete
	Jnit Paving I0mm Natural Ston
	Suspended Paving I0mm Natural Ston
	Public Domain Pavi o council standards
	Public Domain Cros

SS20-4495

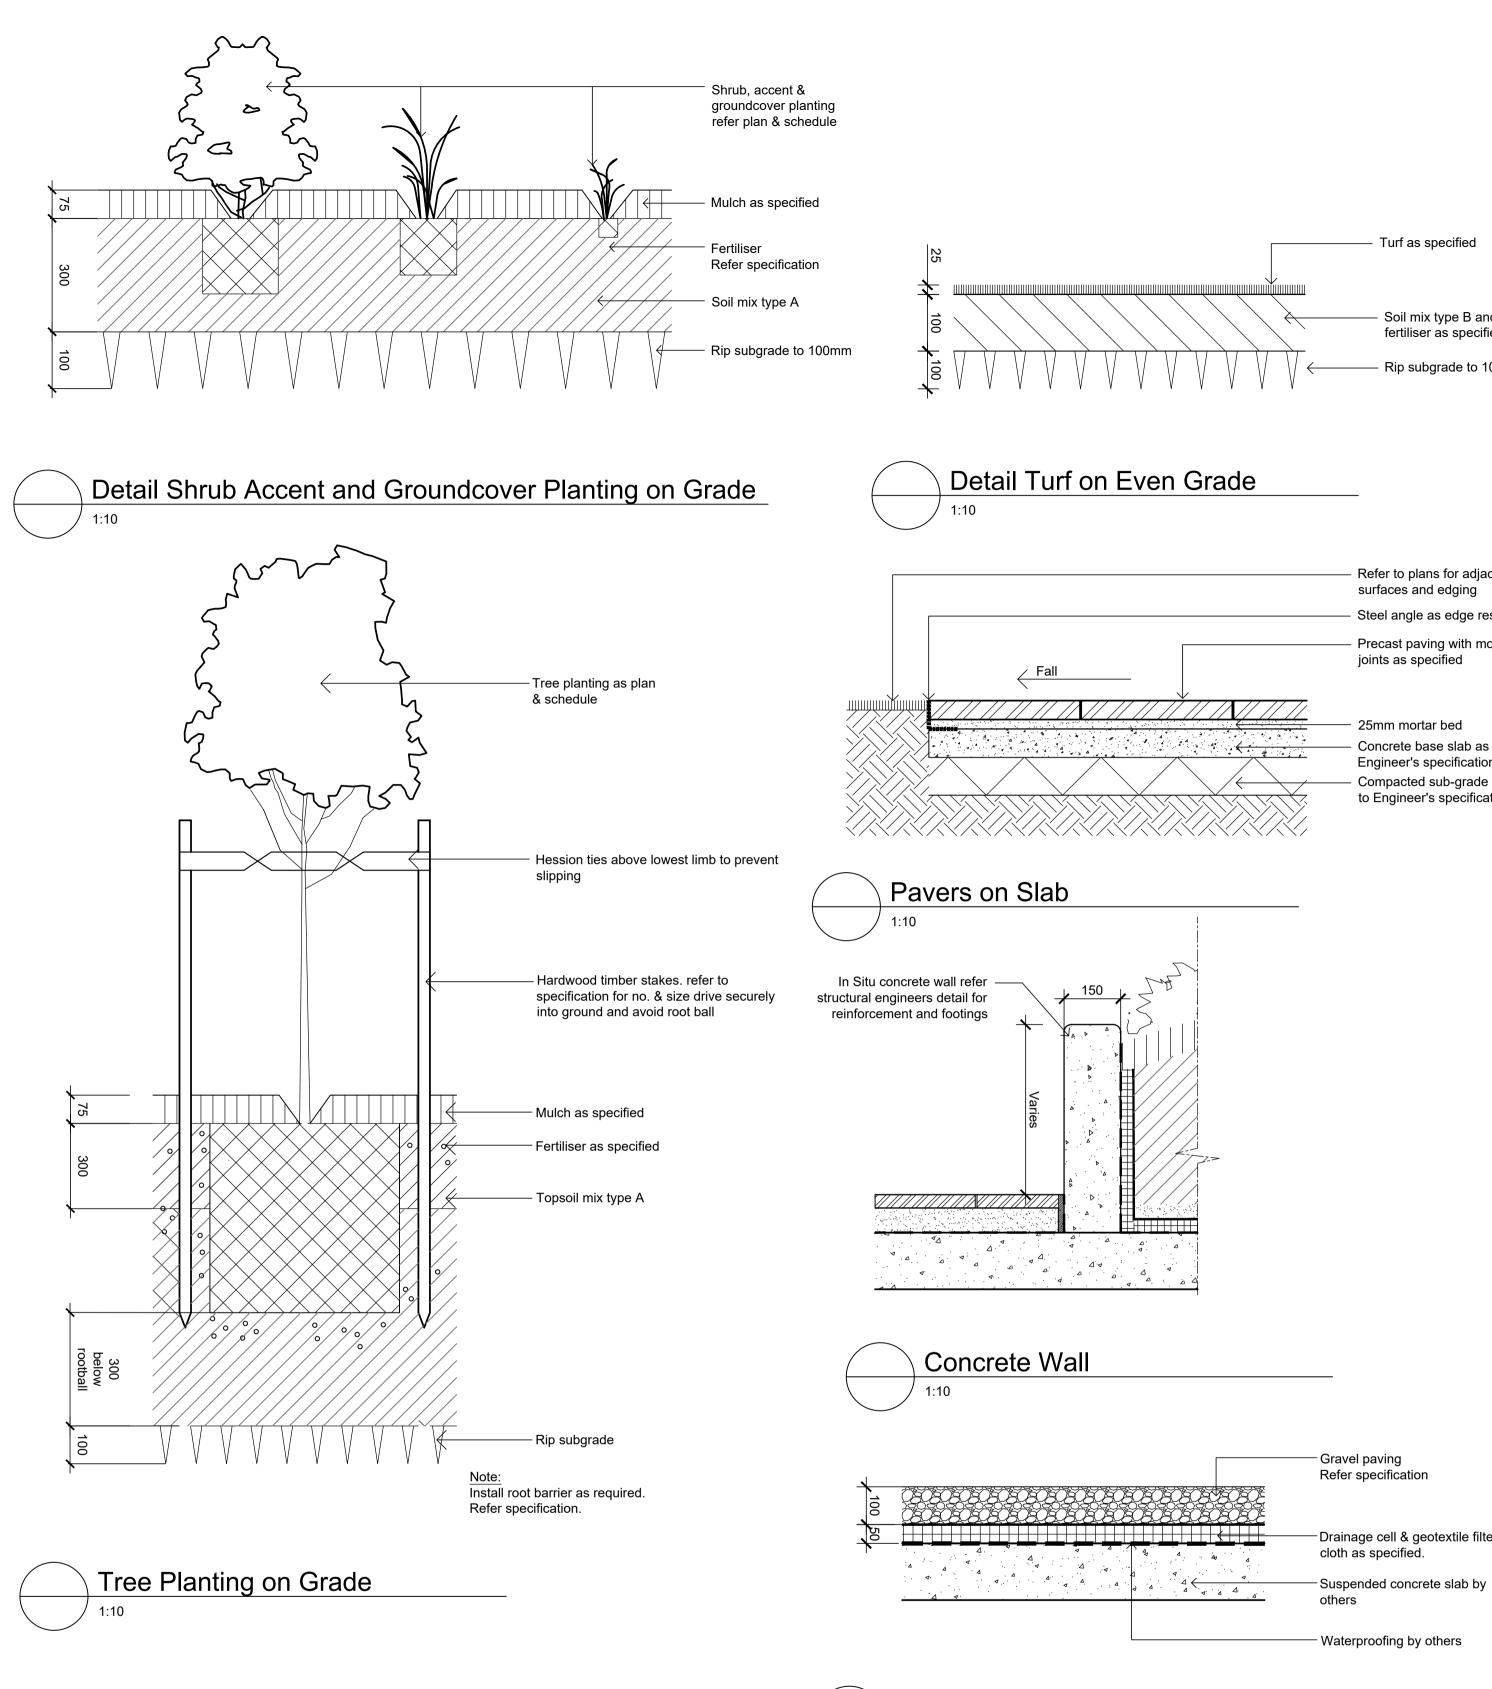

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Revised for Comments D Revised for Comments Civil Coordination в A For Comment Issue Revision Description

JD NM 01.10.2021 JD NM 16.12.2020 JD NM 14.12.2020 JD NM 17.11.2020 Drawn Check Date

LEGEND

1:10

Soil mix type B and fertiliser as specified - Rip subgrade to 100mm


Refer to plans for adjacent surfaces and edging Steel angle as edge restraint Precast paving with mortar joints as specified

Concrete base slab as per Engineer's specification Compacted sub-grade to Engineer's specification

Drainage cell & geotextile filter

Gravel Paving on Slab

Key Plan:

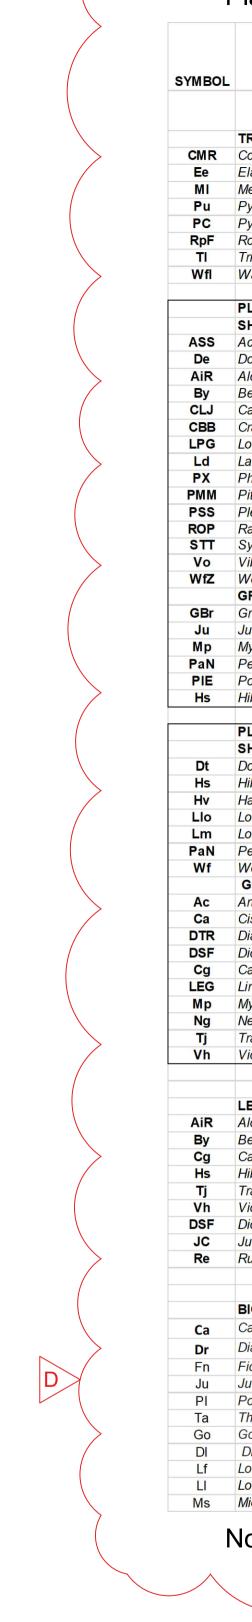



Plant Schedule

D

C

C

BOTANIC NAME	COMMON NAME	MATURE SIZE	SPACING	POTSIZE
		(h x w) (m)		
REES	Elseverine Ores	2.5 2	A = - I =	2001
Corymbia ficifolia Mini Red Elaeocarpus eumundi	Flowering Gum Eumundi Quandong	2.5 x 2 3 x 10	As shown As shown	200L 400L
Aelaleuca linariifolia	Snow in Summer	10 x 5	As shown	400L
Pyrus ussuriensis	Manchurian Pear	10 x 6	As shown	400L
Pyrus 'Capital'	Manchurian Pear	10 x 6	As shown	400L
Robinia pseudoacacia Frisia	Yellow Locust	9 x 6	As shown	400L
ristaniopsis laurina	Water Gum	10 x 8	As shown	400L
Vaterhousia floribunda	Weeping Lilly Pilly	15 x 8	As shown	400L
LANTING TYPE 1				
Acmena smithii 'Sublime'		5 x 2		300mm
Doryanthes excelsa	Gymea Lily	4 x 1.5		300mm
Icantarea imperialis 'Rubra'	Imperial Bromeliad	1 x 1	-	300mm
Beschorneria yuccoides	Mexican lily	.6 x .6		300mm
Callistemon 'Little John'	Dwarf Bottlebrush	1m		300mm
Crassula Bluebird		.6 x .6		300mm
oropetalum 'Plum Gorgeous'	Fringe Flower	.3 x 1.5	mixed	300mm
avandula dentata	Lavender	.6 x .6	species	300mm
Philodendron 'Xanadu'	Xanadu	1 x 1	2/sqm	300mm
Pittosporum 'Miss Muffet'		1 x 1		300mm
Plectranthus argentatus 'Silver Shield'		1 x 1		300mm
Raphiolepis indica 'Oriental Pearl'	Dwarf Lilly Dilly	1 x 1		300mm
Syzygium 'Tiny Trev' /iburnum odoratissum	Dwarf Lilly Pilly Sweet Viburnum	0.6 x 0.6 3 x 2.5		300mm 300mm
Vestringia fruiticosa Zena	Zena Coastal Rosemary	1 x 1	-	300mm
BROUNDCOVERS 4/M2	Zona Obastal Nusellidiy			5001111
Grevillea Bronze rambler	Bronze rambler grevillea	1 x 1		150mm
luncus usiatus	Tussock Rush	1m h		150mm
lyoporum parvifolium	Creeping boobialla	0.2 x 1.5	mixed	150mm
Pennisetum alpecuroides 'Nafray'	Nafray Swamp Foxtail	0.6 x 0.6	species 6/sqm	150mm
Poa labillarderi 'Eskdale'	Poa labillarderi	0.8 x 0.4	0/Sqm	150mm
libbertia scandens	Snake Vine	0.2 x 2		150mm
PLANTING TYPE 2				
SHRUB 1/M2				
Dodonaea triquetra	Hop Bush	3 x 2	-	200mm
libbertia scandens Iardenbergia violacea	Snake Vine	0.2 x 2 0.3 x 3	Mixed	150mm 150mm
omandra longifolia	Happy Wanderer Spiny head mat rush	0.7 x 1m	Species	150mm
omandra multiflora	Lomandra multiflora	.4 x .4	1/m2	150mm
Pennisetum alpecuroides 'Nafray'	Nafray Swamp Foxtail	0.6 x 0.6		150mm
Vestringia fruiticosa	Coastal Rosemary	1 x 1	-	300mm
GRASSES AND GROUNDCOVERS 5/M2				
hthropodium cirratum	Renga Renga Lily	.4 x .4		150mm
Dissus antarctica	Kangaroo Vine	.1 x 2		150mm
Dianella tasmanica 'Tasred'	Tasred Blue Flax Lily	0.4 x 0.4		150mm
Dichondra 'Silver Falls"		.1 x 1	Mixed	150mm
Carpobrotus glaucescens	Pigface	.2 x .1	Species	150mm
iriope muscari 'Evergreen Giant'	Giant Liriope	0.6 x 0.5	5/m2	150mm
lyoporum parvifolium leomarica gracilis	Creeping boobialla Walking Iris	0.2 x 1.5 .4 x .4		150mm 150mm
rachelospermum jasminoides	Star Jasmine	0.3 x 0.6	-	150mm
liola hederacea	Native Violet	0.1 x 3		150mm
EVEL 1 TERRACE PLANTER MIX				
Icantarea imperialis 'Rubra'	Imperial Bromeliad	1 x 1	As Shown	300mm
Beschorneria yuccoides	Mexican lily	.6 x .6	As Shown	300mm
Carpobrotus glaucescens	Pigface	.2 x .1	5/m2	150mm
libbertia scandens rachelospermum iasminoides	Snake Vine	0.2 x 2	4/m2	150mm 150mm
rachelospermum jasminoides /iola hederacea	Star Jasmine Native Violet	0.3 x 0.6 0.1 x 3	4/m2 5/m2	150mm 150mm
Dia nederacea Dichondra 'Silver Falls"		.1 x 1	3/m2 4/lm	150mm
uniperus conferta	Shore Juniper	.3 x 4	5/m2	150mm
Russelia equisetiformis		.5 x 1	4/Im	200mm
	Tall and an	A A		150
Carex appressa	Tall sedge	.4 x .4	-	150mm
Dianella revoluta	Blue flax lily	.4 x .4		150mm
icina nodosa	Knobby club rush	.3 x .4		150mm
uncus usitatus	Common rush	.3 x .4	Mixed	150mm
Poa labillardieri Themeda australis	Eskdale, tussock grass	.5 x .5 .4 x .4	Species	150mm 150mm
nemeda australis Goodenia ovata	Kangaroo grass Hop goodenia	.4 x .4 .1 x .3	8/n2	150mm 150mm
Dianella longifolia	Blueberry lily	.1 x .3		150mm
omandra filiformis	Wattle mat-rush	.4 x .4	-	150mm
omandra longifolia	Tanika, spiny mat-rush	.8 x .8	-	150mm
licrolaena stipoides	Weeping grass	.3 x .3		150mm

Note All landscape areas to be irrigated

Stockland


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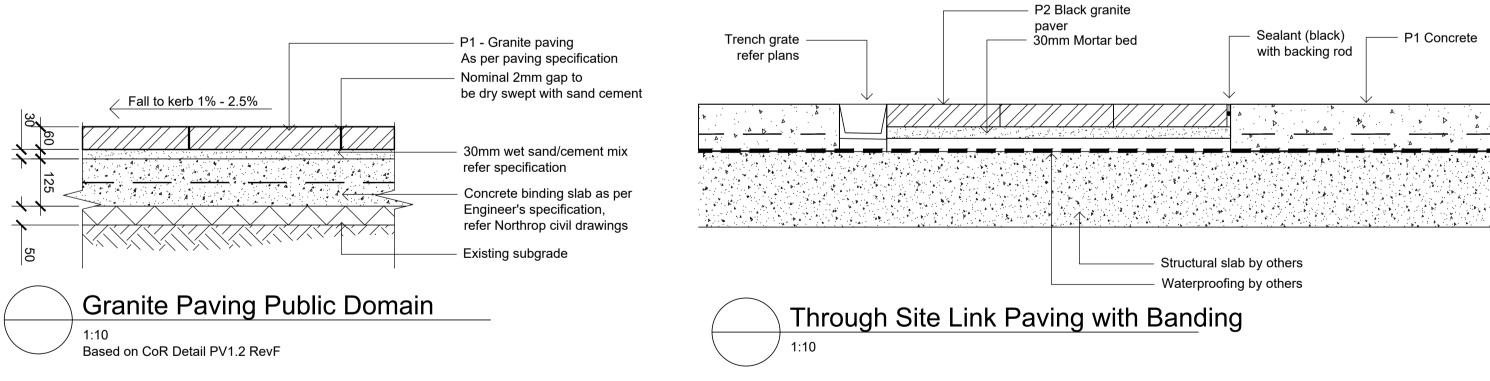
Project: M Park Building C

DEVELOPMENT APPLICATION

Scale: Job Number: SS20-4495

Drawing Number:



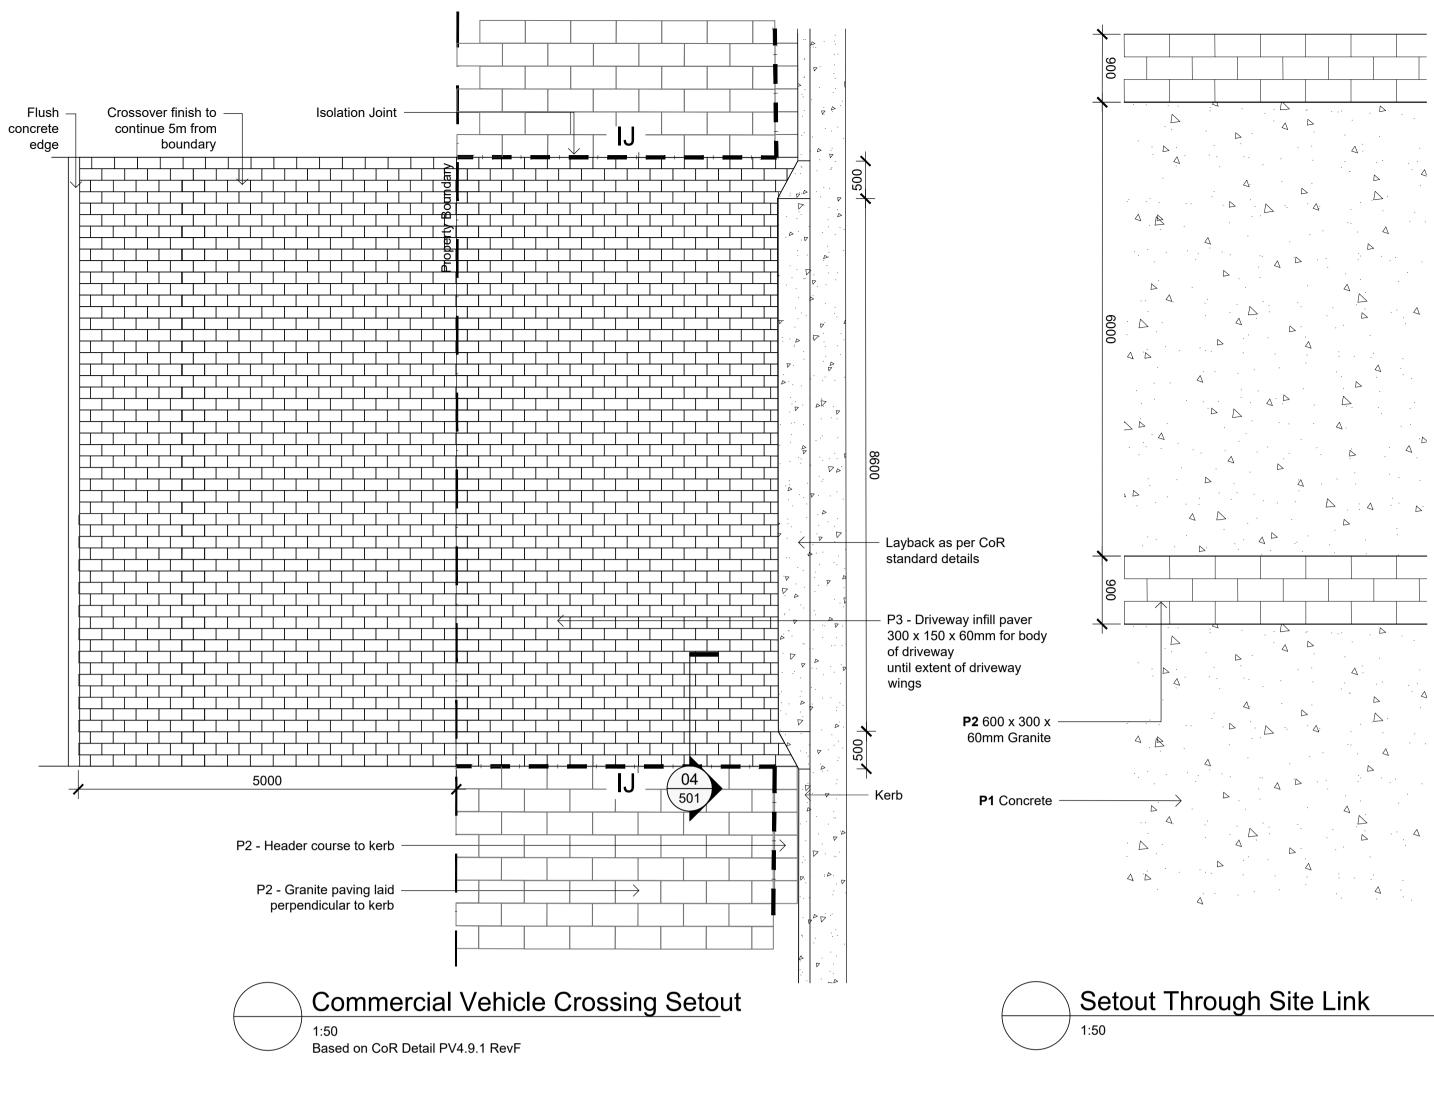

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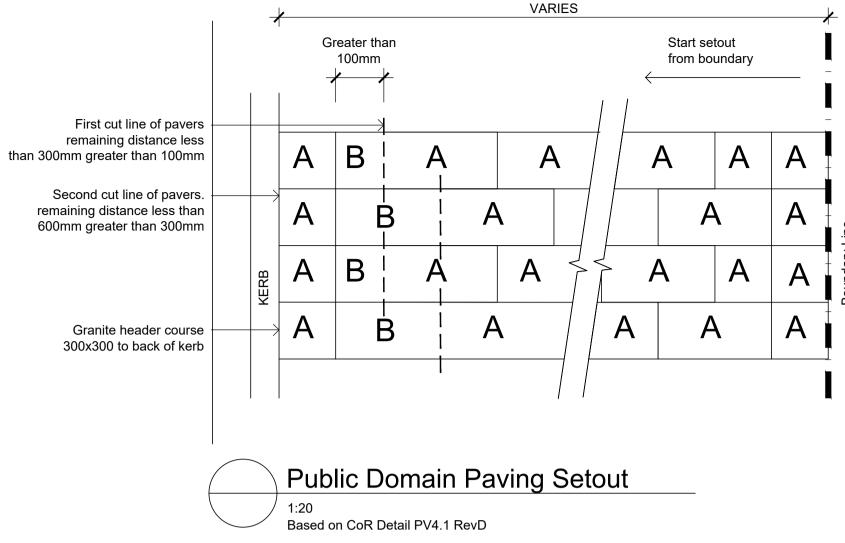
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Revised for council comments Revised for Comments Civil Coordination в A For Comment Issue Revision Description

LEGEND


A = full or half size paver as per granite paving specification. B = paver cut to fit remaining distance Note : if remaining distance is less than 100mm then second setout moves across to the nearest unit larger than 100mm. second cut line is then set off midpoint and third cut line is required. refer pv4.1a



Key Plan:



Client: Stockland

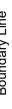

Project: M Park Building C

Drawing Name: Landscape Details Public Domain & VPA

DEVELOPMENT APPLICATION

Scale: Job Number: SS20-4495

Drawing Number:

Issue: 502 D